LOCATION MAP NOT TO SCALE

CONSTRUCTION DRAWINGS for

STUDIO 17 APARTMENTS

LOCATED IN CITY OF WILMINGTON NEW HANOVER COUNTY, NORTH CAROLINA

WATER & SEWER USAGE NOTES:

GENERAL NOTES:

5. THIS SITE IS LOCATED WITHIN ZONE "X" ACCORDING TO FEMA

8. ASBUILT, BOUNDARY AND TOPOGRAPHIC SURVEY PERFORMED

AND PROVIDED TO CSD ENGINEERING BY CAPE FEAR SURVEYING;

9. STORMWATER DRAINS TO BURNT MILL CREEK, C; SW 18-74-63-2


FIRM COMMUNITY PANEL NUMBER 3720312700J, EFFECTIVE

1. NEW HANOVER COUNTY PARCEL NUMBERS.: PID = R05407-029-012-000


6. SITE ADDRESS: 514 S. 17TH STREET 7. EXISTING IMPERVIOUS ONSITE = 11,180 SF

2. TOTAL PROJECT AREA: 28,125 SF (0.65 AC.)
3. EXISTING ZONING DISTRICT: UMX

CURRENT WATER USAGE 50 GPD PROPOSED WATER USAGE 7,730 GPD CURRENT SEWER USAGE 50 GPD PROPOSED SEWER USAGE 7,730 GPD WATER - (32) - 1 BEDROOM X 240 GPD = 7.680 GPD RETAIL - 2 EMPLOYEES = 50 GPDSEWER - (32) - 1 BEDROOM X 240 GPD = 7,680 GPDRETAIL - 2 EMPLOYEES = 50 GPD

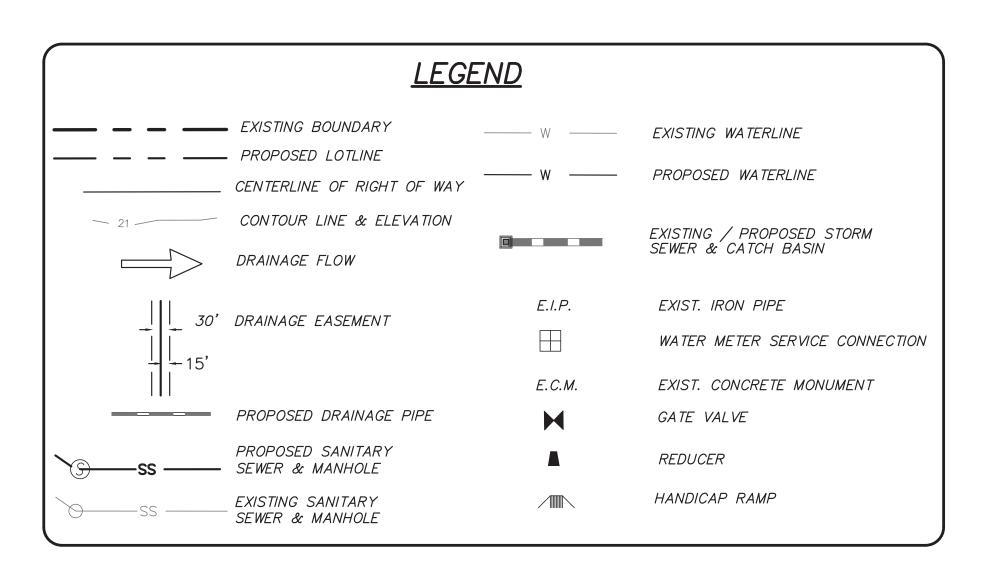

OWNER: MOSLEY PARK, LLC 1319 MILITARY CUTOFF SUITE CC PMB 172 WILMINGTON, NC 28405

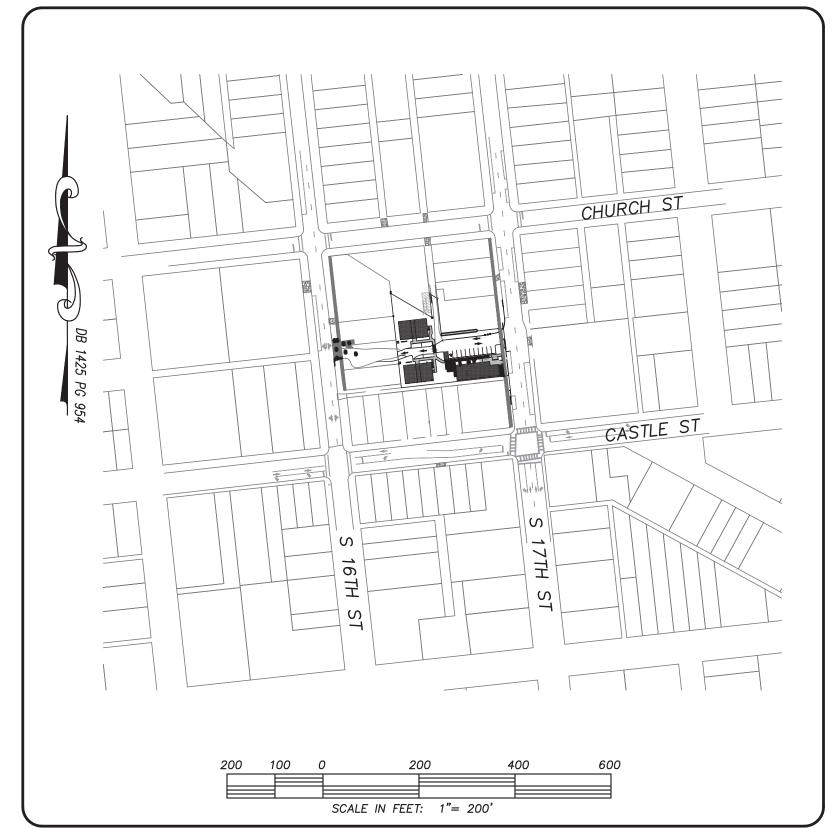

WATER (PUBLIC)						
SIZE	6"	4"	<i>3</i> "			
TYPE	C-900	C-900	SDR-21			
L F	8	5	3			
	WA	TER (PRIVA	TE)			
SIZE	6"	3"	2"			
TYPE	C-900	SDR-21	SDR-21			
_LF	135	132	235			
SEWER (PRIVATE)						
SIZE	6"	6"				
TYPE	C-900	DIP				
\ LF	154	20				

	INDEX TO DRAWINGS					
SHEET No.	SHEET No. DESCRIPTION					
1 OF 12	COVER SHEET	CD_COVER				
2 OF 12	EXISTING BOUNDARY AND TOPOGRAPHY, ADJACENT TRAFFIC	CD_EX-COND				
3 OF 12	SITE PLAN	SITE_PLAN				
4 OF 12	CITY OF WILMINGTON CONSTRUCTION DETAILS	SP_DET-1				
5 OF 12	5 OF 12 CITY OF WILMINGTON CONSTRUCTION DETAILS					
6 OF 12	UTILITY PLAN	UP				
7 OF 12	GRADING PLAN	GRADING				
8 OF 12	CFPUA INSTALLATION DETAILS	CFPUA_WAT_SEW_1				
9 OF 12	CFPUA INSTALLATION DETAILS	CFPUA_WAT_SEW_2				
10 OF 12	CFPUA WATER DETAILS	CFPUA_WATER				
11 OF 12	CFPUA SEWER DETAILS	CFPUA_SEWER_1				
12 OF 12	12 OF 12 CFPUA SEWER DETAILS LP1 OF LP1 LANDSCAPING PLAN 1 OF 3 NCDOT ENCROACHMENT PLAN					
LP1 OF LP1						
1 OF 3						
2 OF 3	NCDOT TRAFFIC CONTROL PLAN	DOT_TCP				
3 OF 3	NCDOT STANDARD DETAILS	DOT_DET				

For each open utility cut of City streets, a \$325 permit shall be required from the City prior to occupancy and/or project acceptance.

Approved Construction Plan	
Name Date	
Planning	
Traffic	Date
Fire	Sign

Public Services Engineering Division APPROVED DRAINAGE PLAN

____Permit #_

- 1. ASBUILT, BOUNDARY AND TOPOGRAPHIC SURVEY PERFORMED AND PROVIDED TO CSD ENGINEERING BY CAPE FEAR SURVEYING: 1 NORTH 6TH STREET WILMINGTON, NC 28401, 910-762-9496 FIRM #C-3199
- 2. THIS MAP IS NOT FOR CONVEYANCE, RECORDATION, OR SALES. 3. THIS PROPERTY IS LOCATED WITHIN ZONE "X"
- ACCORDING TO THE FEMA FLOOD INSURANCE RATE MAP, 3720312700J, EFFECTIVE DATE 4/3/06
- 4. THIS PROPERTY IS ZONED UMX
- 5. CFPUA WATER
- 7. ALL CONSTRUCTION TO CONFORM TO NEW HANOVER COUNTY STANDARDS AND APPLICABLE STATE & LOCAL CODES.
- 8. CONTRACTOR TO COORDINATE ANY REQUIRED TRAFFIC CONTROL WITH CITY OF WILMINGTON AND OR NCDOT.
- 9. CARE SHALL BE TAKEN DURING FINAL GRADING TO ENSURE POSITIVE DRAINAGE AWAY FROM BUILDINGS AND TO RECEIVING STRUCTURES. ROOF DRAIN DOWNSPOUTS TO BE CONNECTED TO STORM DRAINAGE
- STUBOUTS OR DIRECTED TO STREET/PARKING AREAS. 10. CONTRACTOR IS RESPONSIBLE FOR COORDINATION OF ANY RELOCATIONS, RE-ALIGNMENTS, DISCONNECTIONS OR CONNECTIONS OF EXISTING UTILITIES WITH APPLICABLE AUTHORITIES.
- 11. CLEARING AND GRUBBING OF SITE TO INCLUDE REMOVAL OF EXISTING CURB, ASPHALT, INLETS, AND ANY OTHER STRUCTURES INCLUDING TREES, STUMPS AND DEBRIS EXISTING ON SITE. TREES NOT REQUIRED TO BE CLEARED FOR CONSTRUCTION SHALL REMAIN UNLESS OTHERWISE DIRECTED
- 12. INFORMATION CONCERNING UNDERGROUND UTILITIES WAS OBTAINED FROM AVAILABLE RECORDS. IT SHALL BE THE RESPONSIBILITY OF THE CONTRACTOR TO DETERMINE THE EXACT ELEVATIONS AND LOCATIONS OF ALL EXISTING UTILITIES AT ALL CROSSINGS PRIOR TO COMMENCING TRENCH EXCAVATION. IF ACTUAL CLEARANCES ARE LESS THAN INDICATED ON PLAN, THE CONTRACTOR SHALL CONTACT THE DESIGN ENGINEER BEFORE PROCEEDING WITH CONSTRUCTION. ANY CONDITION DISCOVERED OR EXISTING THAT WOULD NECESSITATE A MODIFICATION OF THESE PLANS SHALL BE BROUGHT TO THE ATTENTION OF THE DESIGN ENGINEER BEFORE PROCEEDING
- 13. NO CONSTRUCTION IS TO BEGIN BEFORE LOCATION OF EXISTING UTILITIES HAS BEEN DETERMINED. CALL "NC ONE—CALL" AT LEAST 48 HOURS BEFORE COMMENCING CONSTRUCTION.
- 14. CONTRACTOR SHALL ADJUST ALL MANHOLES, VALVE & CURB BOXES TO FINAL GRADE UPON COMPLETION OF ALL CONSTRUCTION. ANY BOXES DAMAGED OR OTHERWISE DISTURBED BY THE CONTRACTOR SHALL BE REPAIRED AT THE EXPENSE OF THE CONTRACTOR.
- 15. THE CONTRACTOR IS RESPONSIBLE FOR CONTROLLING DUST AND EROSION DURING CONSTRUCTION AT HIS EXPENSE. PARKING AREAS SHALL BE WATERED TO CONTROL DUST WHEN ORDERED BY THE ENGINEER.
- 16. NO GEOTECHNICAL TESTING HAS BEEN PERFORMED ON SITE. NO WARRANTY IS MADE FOR SUITABILITY OF SUBGRADE, AND UNDERCUT AND ANY REQUIRED REPLACEMENT WITH SUITABLE MATERIAL SHALL BE THE RESPONSIBILITY OF THE CONTRACTOR.
- 17. CONTRACTOR TO ENSURE THAT PAVEMENT IS PLACED SO AS TO DRAIN POSITIVELY TO THE STREET INLETS AND CATCH BASINS. ALL FUTURE ROOF DRAIN DOWNSPOUTS TO BE DIRECTED TO THE STORM DRAINAGE STUBOUTS.
- 18. CONTRACTOR IS RESPONSIBLE FOR OBTAINING ALL REQUIRED PERMITS. 19. THIS PLAN IS FOR SITE GRADING, UTILITIES, SITING, AND DRAINAGE ONLY.
- SEE BUILDING PLANS FOR DETAILED HOOKUPS TO BUILDINGS, ETC. 20. CONTRACTOR AND BUILDER ARE RESPONSIBLE FOR COORDINATING
- FINISHED FLOOR ELEVATION OF ALL BUILDINGS WITH THE OWNER. ELEVATIONS GIVEN ARE MINIMUM GROUND ELEVATIONS AT THE BUILDING SITE AND DO NOT PURPORT TO BE FINISHED FLOOR. MINIMUM RECOMMENDED FF ELEVATIONS SHOWN ON PLANS.
- 21. AFFECTED NON-MUNICIPAL UTILITIES SHALL BE CONTACTED AND PROVIDED WITH PLANS AND OTHER PERTINENT INFORMATION, WHEN FEASIBLE, TO COORDINATE APPROPRIATE SCHEDULING AND PLACEMENT.
- 22. EXTREME CARE SHALL BE TAKEN TO ENSURE MINIMUM SEPARATIONS AT ALL UTILITY CROSSINGS.
- 23. MINIMUM SEPARATION SHALL BE MAINTAINED AS FOLLOWS: a. HORIZONTAL SEPARATION OF 10 FEET BETWEEN SANITARY SEWER AND WATER MAINS AND STORM SEWER.
- b. WHERE VERTICAL CLEARANCE IS LESS THAN 24" BETWEEN SANITARY SEWER AND WATER OR WHERE SEWER LINE CROSSES ABOVE WATER MAIN, BOTH PIPES SHALL BE DUCTILE IRON PIPE FOR A MINIMUM OF 10' EITHER SIDE OF CROSSING.
- c. WHERE VERTICAL CLEARANCE IS LESS THAN 24" BETWEEN SANITARY SEWER AND STORM DRAIN, SANITARY SEWER SHALL BE DUCTILE IRON
- PIPE FOR A MINIMUM OF 10 FEET EITHER SIDE OF CROSSING. d. WHERE VERTICAL CLEARANCE IS LESS THAN 12" BETWEEN SANITARY SEWER AND STORM DRAIN, SANITARY SEWER SHALL BE DUCTILE IRON PIPE FOR A MINIMUM OF 10' EITHER SIDE OF CROSSING. AND BRIDGING SHALL BE INSTALLED PER APPLICABLE UTILITY AUTHORITY'S DETAILS.
- e. IN NO CASE SHALL THERE BE LESS THAN 18" OF SEPARATION BETWEEN OUTSIDE OF WATER MAIN AND OUTSIDE OF SEWER OR STORM DRAINAGE.
- f. MINIMUM COVER OF 36" SHALL BE PROVIDED FOR ALL BURIED WATER MAINS AND SANITARY SEWER MAINS.
- 24. SEE DETAIL SHEETS FOR TYPICAL UTILITIES HOOKUPS.
- 25. ALL SANITARY SEWER MAINS TO BE 8" UNLESS OTHERWISE INDICATED.
- 26. ALL WATER MAINS TO BE 8" UNLESS OTHERWISE INDICATED.
- 27. TWO VALVES ARE REQUIRED AT "T" INTERSECTIONS AND ONE VALVE ON THE WATER LINE TO FIRE HYDRANTS.
- 28. A BLOW-OFF VALVE IS REQUIRED AT THE TERMINUS OF ALL "DEAD END" WATER LINES.


ENGINEERING

LICENSE # C-2710 **ENGINEERING** LAND PLANNING

COMMERCIAL / RESIDENTIAL P.O. BOX 4041

WILMINGTON, NC 28406

(910) 791–4441

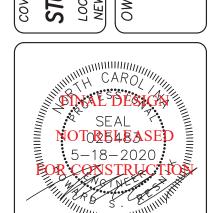


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5-18-20	2-10-20	5-26-19	1-18-19	2-11-18	5-29-18	2-7-18	3-21-18	BY DATE	
RLW	RLW	MRB	MRB	MRB	MRB	RLW	RLW	ВУ	
PLOTTED FOR TRC SIGNATURE	REVISED BUILDING 3 AND SIDEWALK	REVISED WATER/FIRE MAIN LOCATION & WATER MAIN SIZE	REVISED SHEET NUMBERING PER NEW CFPUA DETAILS	REVISED SEWER MAIN TABLES	REVISED WATER MAIN TABLES	REVISED PER TRC COMMENTS	REVISED PER TRC COMMENTS	REMARKS	
8	7	9	5	4	3	2	1	EV. NO.	


(DATE: 1-22-18

HORZ. SCALE: 1" = 200' VERT. SCALE: N/A DRAWN BY: MRB

CHECKED BY: HSR PROJECT NO.: 17-0434

Sheet No. _____ Of _____

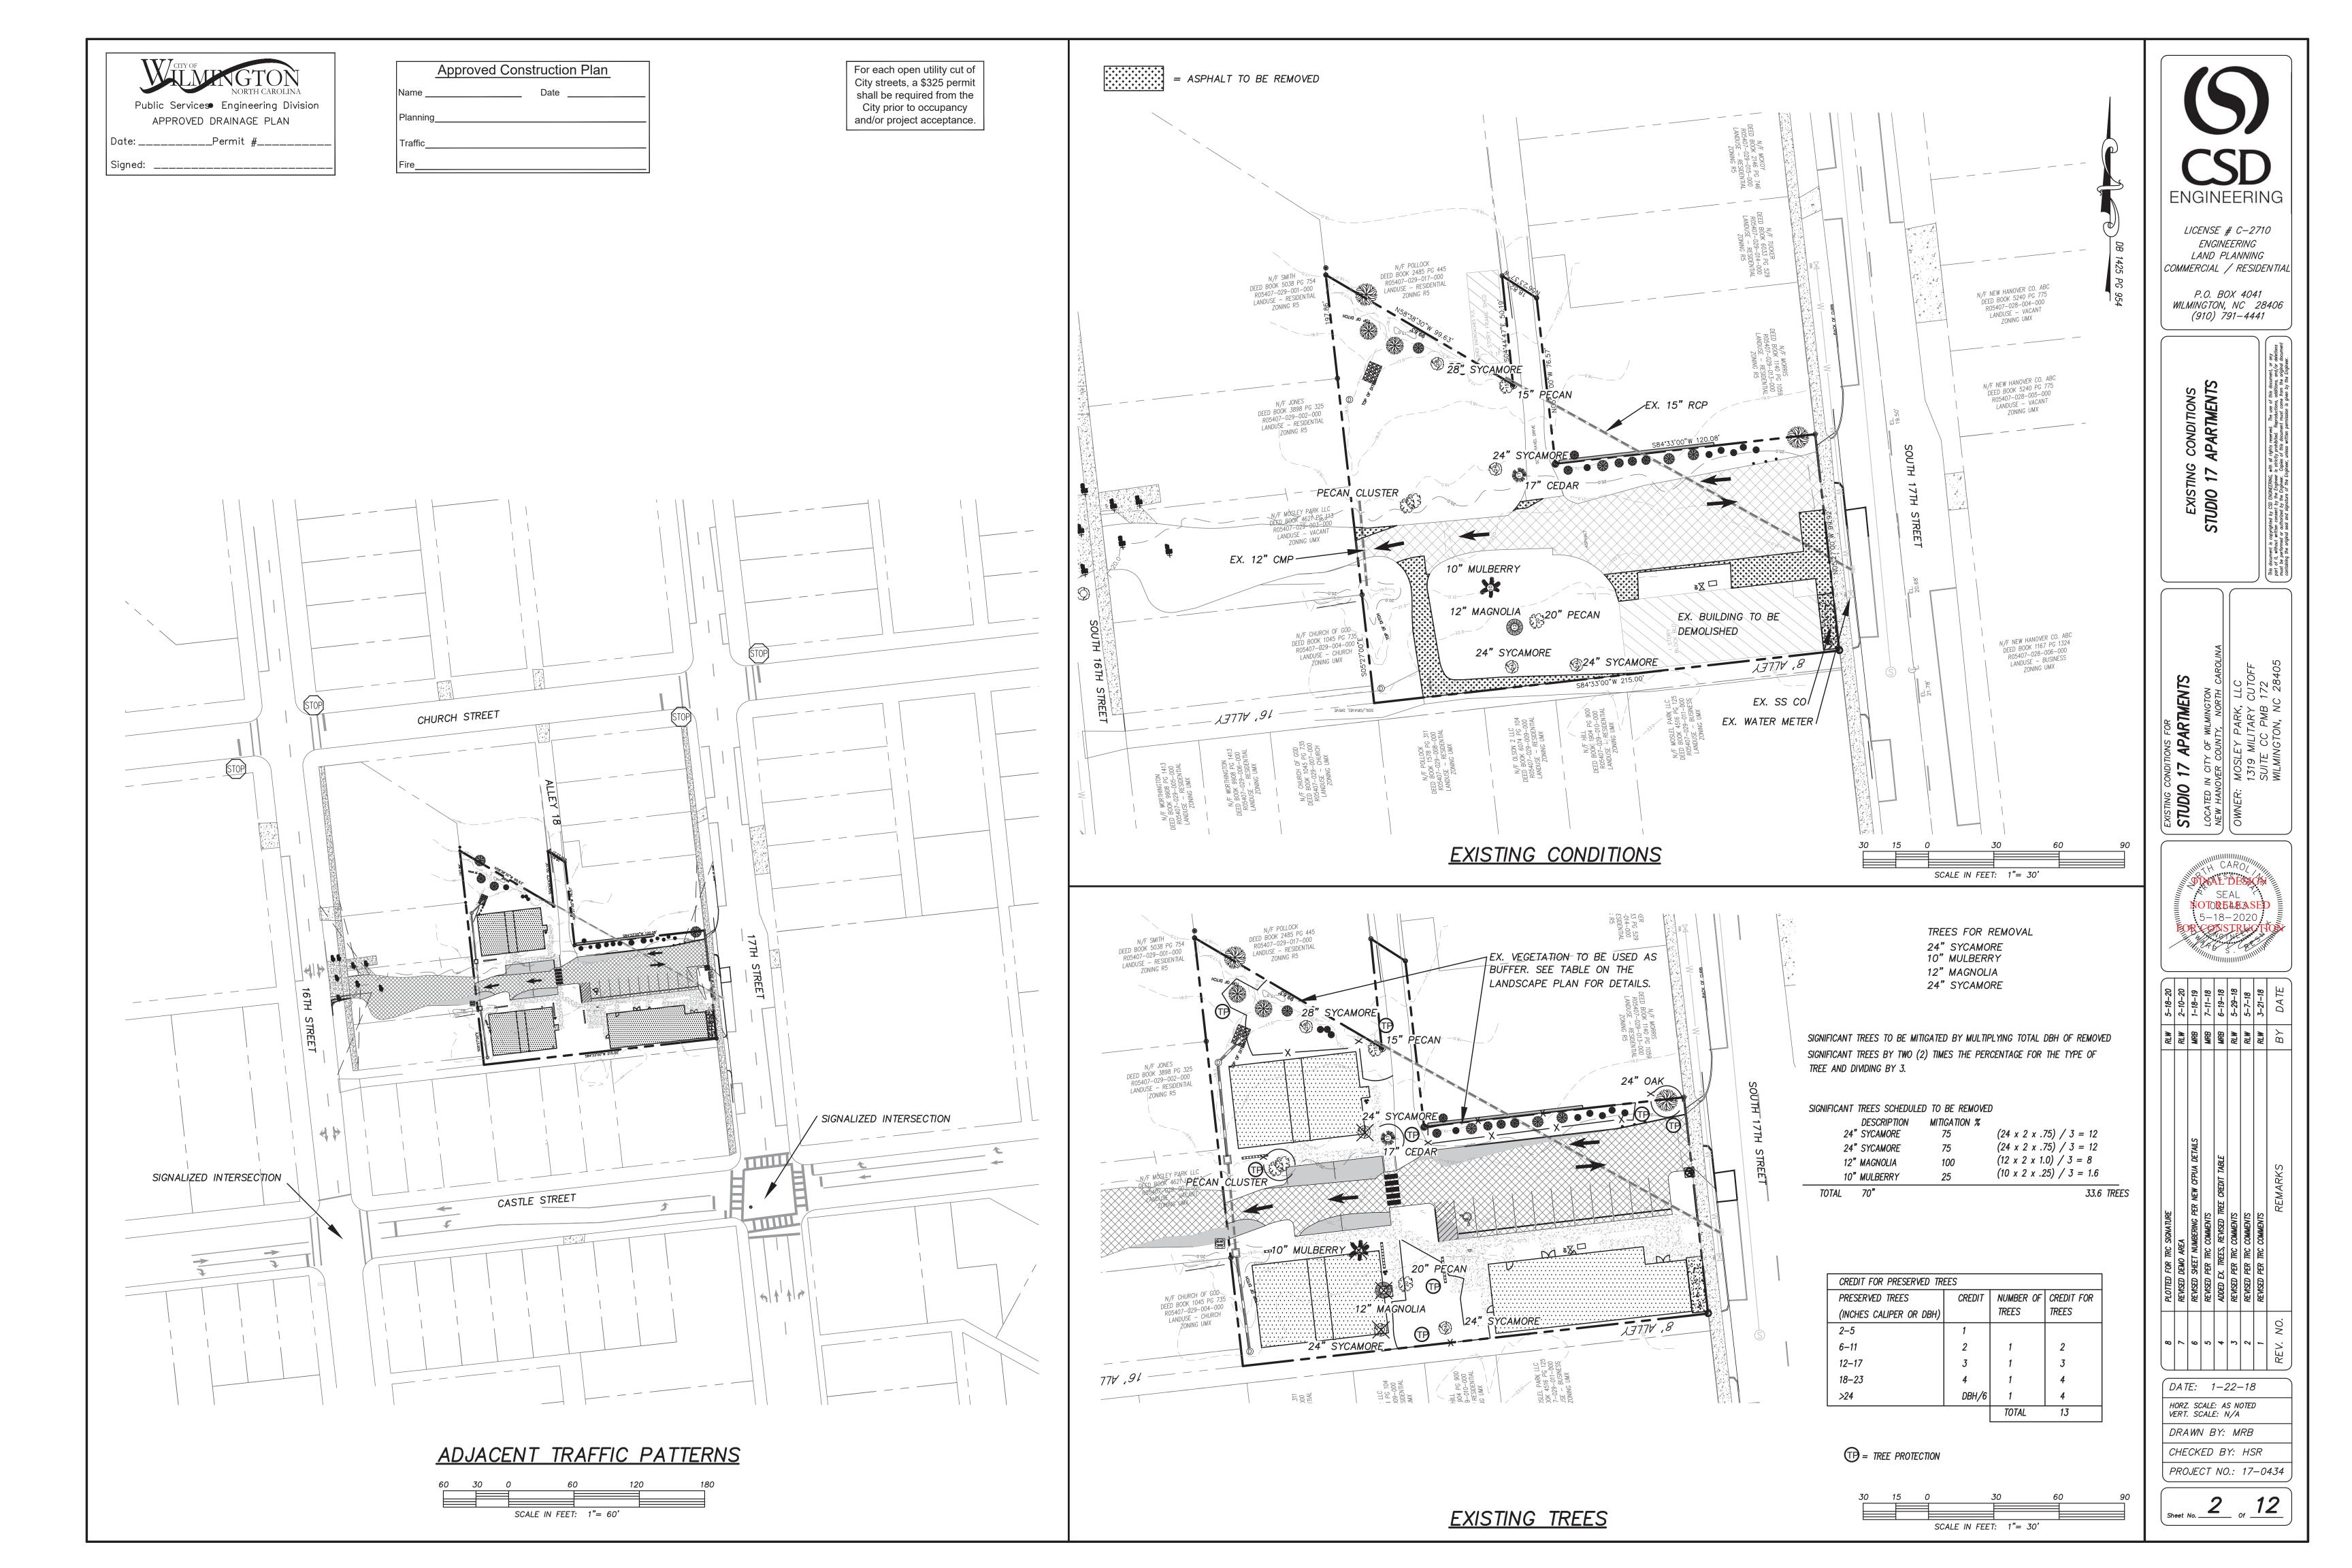

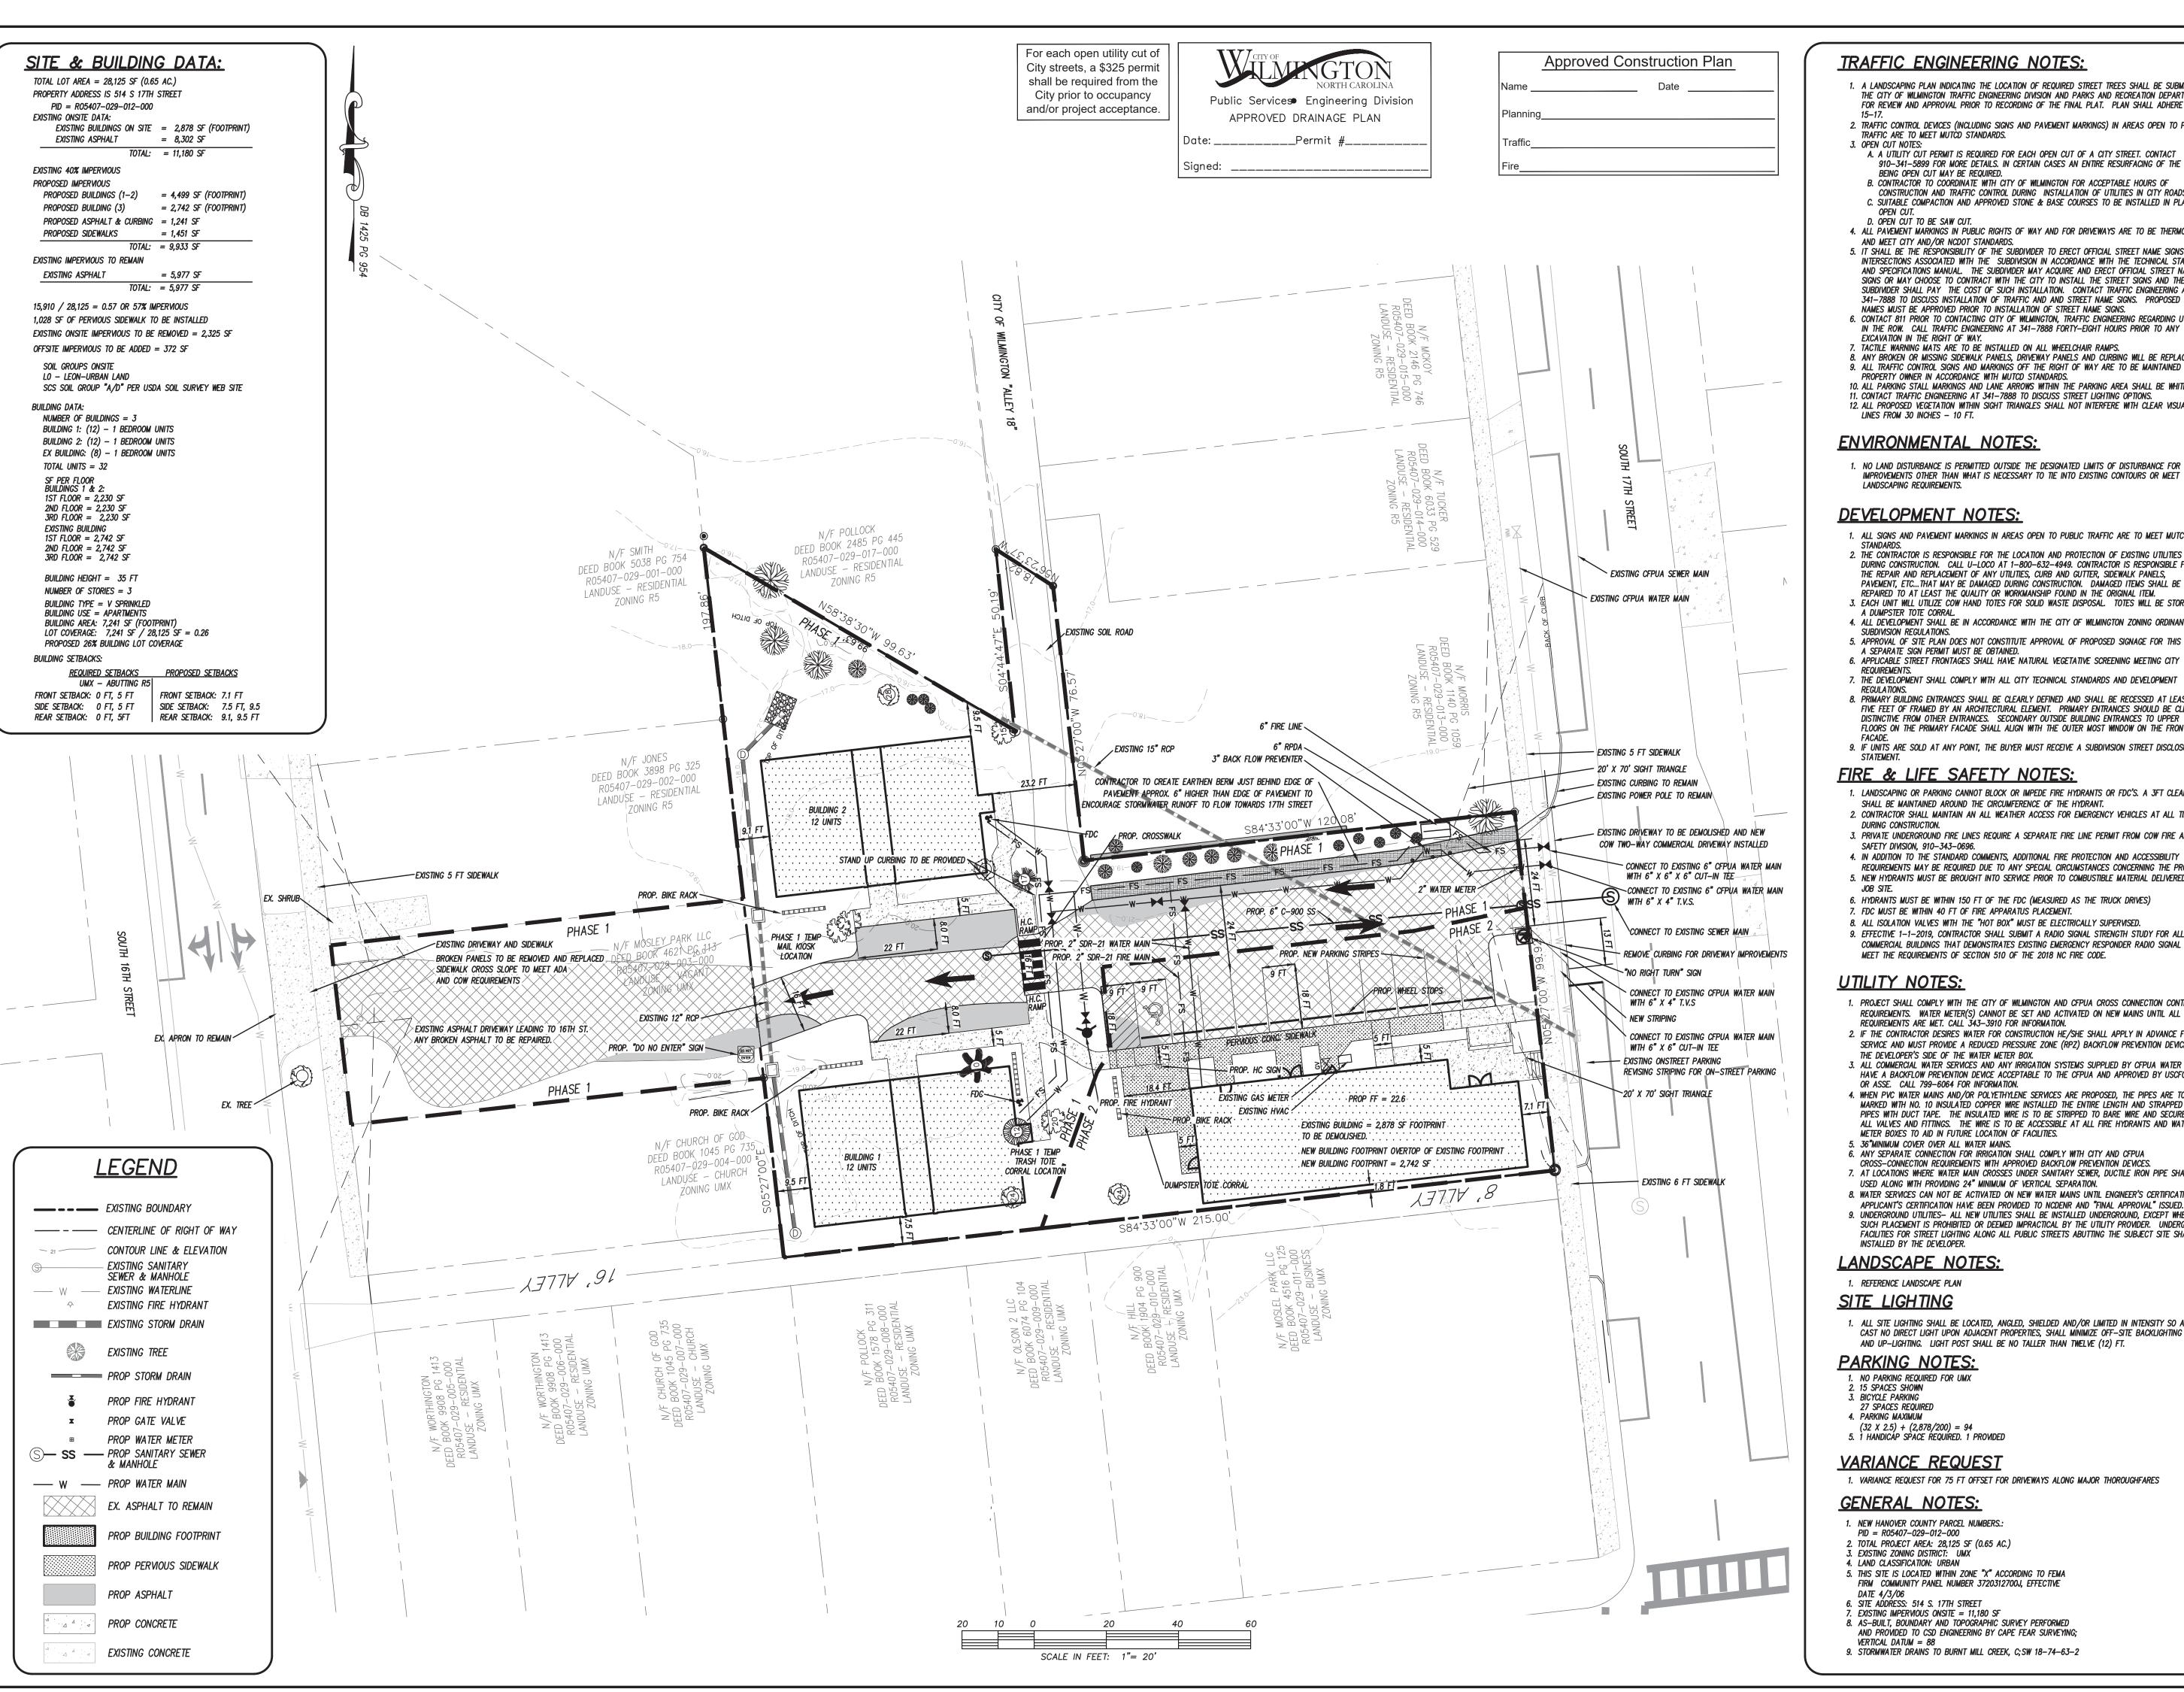

TRAFFIC ENGINEERING NOTES:

- 1. A LANDSCAPING PLAN INDICATING THE LOCATION OF REQUIRED STREET TREES SHALL BE SUBMITTED TO THE CITY OF WILMINGTON TRAFFIC ENGINEERING DIVISION AND PARKS AND RECREATION DEPARTMENT FOR REVIEW AND APPROVAL PRIOR TO RECORDING OF THE FINAL PLAT. PLAN SHALL ADHERE TO SD
- 2. TRAFFIC CONTROL DEVICES (INCLUDING SIGNS AND PAVEMENT MARKINGS) IN AREAS OPEN TO PUBLIC TRAFFIC ARE TO MEET MUTCD STANDARDS.
- A. A UTILITY CUT PERMIT IS REQUIRED FOR EACH OPEN CUT OF A CITY STREET. CONTACT 910-341-5899 FOR MORE DETAILS. IN CERTAIN CASES AN ENTIRE RESURFACING OF THE AREA BEING OPEN CUT MAY BE REQUIRED.
- B. CONTRACTOR TO COORDINATE WITH CITY OF WILMINGTON FOR ACCEPTABLE HOURS OF CONSTRUCTION AND TRAFFIC CONTROL DURING INSTALLATION OF UTILITIES IN CITY ROADS. C. SUITABLE COMPACTION AND APPROVED STONE & BASE COURSES TO BE INSTALLED IN PLACE OF
- D. OPEN CUT TO BE SAW CUT. 4. ALL PAVEMENT MARKINGS IN PUBLIC RIGHTS OF WAY AND FOR DRIVEWAYS ARE TO BE THERMOPLASTIC
- AND MEET CITY AND/OR NCDOT STANDARDS. 5. IT SHALL BE THE RÉSPONSIBILITY OF THE SUBDIVIDER TO ERECT OFFICIAL STREET NAME SIGNS AT ALL INTERSECTIONS ASSOCIATED WITH THE SUBDIVISION IN ACCORDANCE WITH THE TECHNICAL STANDARDS AND SPECIFICATIONS MANUAL. THE SUBDIVIDER MAY ACQUIRE AND ERECT OFFICIAL STREET NAME SIGNS OR MAY CHOOSE TO CONTRACT WITH THE CITY TO INSTALL THE STREET SIGNS AND THE SUBDIVIDER SHALL PAY THE COST OF SUCH INSTALLATION. CONTACT TRAFFIC ENGINEERING AT
- 341–7888 TO DISCUSS INSTALLATION OF TRAFFIC AND AND STREET NAME SIGNS. PROPOSED STREET NAMES MUST BE APPROVED PRIOR TO INSTALLATION OF STREET NAME SIGNS. 6. CONTACT 811 PRIOR TO CONTACTING CITY OF WILMINGTON, TRAFFIC ENGINEERING REGARDING UTILITIES IN THE ROW. CALL TRAFFIC ENGINEERING AT 341-7888 FORTY-EIGHT HOURS PRIOR TO ANY
- EXCAVATION IN THE RIGHT OF WAY. 7. TACTILE WARNING MATS ARE TO BE INSTALLED ON ALL WHEELCHAIR RAMPS.
- 8. ANY BROKEN OR MISSING SIDEWALK PANELS, DRIVEWAY PANELS AND CURBING WILL BE REPLACED. 9. ALL TRAFFIC CONTROL SIGNS AND MARKINGS OFF THE RIGHT OF WAY ARE TO BE MAINTAINED BY THE PROPERTY OWNER IN ACCORDANCE WITH MUTCO STANDARDS
- 10. ALL PARKING STALL MARKINGS AND LANE ARROWS WITHIN THE PARKING AREA SHALL BE WHITE. 11. CONTACT TRAFFIC ENGINEERING AT 341-7888 TO DISCUSS STREET LIGHTING OPTIONS. 12. ALL PROPOSED VEGETATION WITHIN SIGHT TRIANGLES SHALL NOT INTERFERE WITH CLEAR VISUAL SIGHT

ENVIRONMENTAL NOTES:

1. NO LAND DISTURBANCE IS PERMITTED OUTSIDE THE DESIGNATED LIMITS OF DISTURBANCE FOR SITE IMPROVEMENTS OTHER THAN WHAT IS NECESSARY TO TIE INTO EXISTING CONTOURS OR MEET LANDSCAPING REQUIREMENTS.

DEVELOPMENT NOTES:

- 1. ALL SIGNS AND PAVEMENT MARKINGS IN AREAS OPEN TO PUBLIC TRAFFIC ARE TO MEET MUTCO 2. THE CONTRACTOR IS RESPONSIBLE FOR THE LOCATION AND PROTECTION OF EXISTING UTILITIES DURING CONSTRUCTION. CALL U-LOCO AT 1-800-632-4949. CONTRACTOR IS RESPONSIBLE FOR THE REPAIR AND REPLACEMENT OF ANY UTILITIES. CURB AND GUTTER. SIDEWALK PANELS. PAVEMENT, ETC...THAT MAY BE DAMAGED DURING CONSTRUCTION. DAMAGED ITEMS SHALL BE
- REPAIRED TO AT LEAST THE QUALITY OR WORKMANSHIP FOUND IN THE ORIGINAL ITEM. 3. EACH UNIT WILL UTILIZE COW HAND TOTES FOR SOLID WASTE DISPOSAL. TOTES WILL BE STORED IN
- 4. ALL DEVELOPMENT SHALL BE IN ACCORDANCE WITH THE CITY OF WILMINGTON ZONING ORDINANCE & SURDIVISION REGULATIONS. 5. APPROVAL OF SITE PLAN DOES NOT CONSTITUTE APPROVAL OF PROPOSED SIGNAGE FOR THIS SITE. A SEPARATE SIGN PERMIT MUST BE OBTAINED.
- 7. THE DEVELOPMENT SHALL COMPLY WITH ALL CITY TECHNICAL STANDARDS AND DEVELOPMENT
- 8. PRIMARY BUILDING ENTRANCES SHALL BE CLEARLY DEFINED AND SHALL BE RECESSED AT LEAST FIVE FEET OF FRAMED BY AN ARCHITECTURAL ELEMENT. PRIMARY ENTRANCES SHOULD BE CLEARLY DISTINCTIVE FROM OTHER ENTRANCES. SECONDARY OUTSIDE BUILDING ENTRANCES TO UPPER FLOORS ON THE PRIMARY FACADE SHALL ALIGN WITH THE OUTER MOST WINDOW ON THE FRONT
- 9. IF UNITS ARE SOLD AT ANY POINT, THE BUYER MUST RECEIVE A SUBDIVISION STREET DISCLOSURE

FIRE & LIFE SAFETY NOTES:

- 1. LANDSCAPING OR PARKING CANNOT BLOCK OR IMPEDE FIRE HYDRANTS OR FDC'S. A 3FT CLEAR SPACE SHALL BE MAINTAINED AROUND THE CIRCUMFERENCE OF THE HYDRANT. 2. CONTRACTOR SHALL MAINTAIN AN ALL WEATHER ACCESS FOR EMERGENCY VEHICLES AT ALL TIMES
- 3. PRIVATE UNDERGROUND FIRE LINES REQUIRE A SEPARATE FIRE LINE PERMIT FROM COW FIRE AND LIFE SAFETY DIVISION, 910-343-0696.
- 4. IN ADDITION TO THE STANDARD COMMENTS, ADDITIONAL FIRE PROTECTION AND ACCESSIBILITY REQUIREMENTS MAY BE REQUIRED DUE TO ANY SPECIAL CIRCUMSTANCES CONCERNING THE PROJECT. 5. NEW HYDRANTS MUST BE BROUGHT INTO SERVICE PRIOR TO COMBUSTIBLE MATERIAL DELIVERED TO THE
- 6. HYDRANTS MUST BE WITHIN 150 FT OF THE FDC (MEASURED AS THE TRUCK DRIVES)
- 7. FDC MUST BE WITHIN 40 FT OF FIRE APPARATUS PLACEMENT.
- 8. ALL ISOLATION VALVES WITH THE "HOT BOX" MUST BE ELECTRICALLY SUPERVISED. 9. EFFECTIVE 1-1-2019, CONTRACTOR SHALL SUBMIT A RADIO SIGNAL STRENGTH STUDY FOR ALL COMMERCIAL BUILDINGS THAT DEMONSTRATES EXISTING EMERGENCY RESPONDER RADIO SIGNAL LEVELS MEET THE REQUIREMENTS OF SECTION 510 OF THE 2018 NC FIRE CODE.

UTILITY NOTES:

- 1. PROJECT SHALL COMPLY WITH THE CITY OF WILMINGTON AND CFPUA CROSS CONNECTION CONTROL
- REQUIREMENTS. WATER METER(S) CANNOT BE SET AND ACTIVATED ON NEW MAINS UNTIL ALL REQUIREMENTS ARE MET. CALL 343-3910 FOR INFORMATION.
- 2. IF THE CONTRACTOR DESIRES WATER FOR CONSTRUCTION HE/SHE SHALL APPLY IN ADVANCE FOR THIS SERVICE AND MUST PROVIDE A REDUCED PRESSURE ZONE (RPZ) BACKFLOW PREVENTION DEVICE ON THE DEVELOPER'S SIDE OF THE WATER METER BOX.
- 3. ALL COMMERCIAL WATER SERVICES AND ANY IRRIGATION SYSTEMS SUPPLIED BY CFPUA WATER SHALL HAVE A BACKFLOW PREVENTION DEVICE ACCEPTABLE TO THE CFPUA AND APPROVED BY USCFCCCHR OR ASSE. CALL 799-6064 FOR INFORMATION. 4. WHEN PVC WATER MAINS AND/OR POLYETHYLENE SERVICES ARE PROPOSED, THE PIPES ARE TO BE
- MARKED WITH NO. 10 INSULATED COPPER WIRE INSTALLED THE ENTIRE LENGTH AND STRAPPED TO THE PIPES WITH DUCT TAPE. THE INSULATED WIRE IS TO BE STRIPPED TO BARE WIRE AND SECURED TO ALL VALVES AND FITTINGS. THE WIRE IS TO BE ACCESSIBLE AT ALL FIRE HYDRANTS AND WATER METER BOXES TO AID IN FUTURE LOCATION OF FACILITIES. 5. 36"MINIMUM COVER OVER ALL WATER MAINS.
- 6. ANY SEPARATE CONNECTION FOR IRRIGATION SHALL COMPLY WITH CITY AND CFPUA CROSS-CONNECTION REQUIREMENTS WITH APPROVED BACKFLOW PREVENTION DEVICES.
- 7. AT LOCATIONS WHERE WATER MAIN CROSSES UNDER SANITARY SEWER, DUCTILE IRON PIPE SHALL BE USED ALONG WITH PROVIDING 24" MINIMUM OF VERTICAL SEPARATION.
- 8. WATER SERVICES CAN NOT BE ACTIVATED ON NEW WATER MAINS UNTIL ENGINEER'S CERTIFICATION AND
- APPLICANT'S CERTIFICATION HAVE BEEN PROVIDED TO NCDENR AND "FINAL APPROVAL" ISSUED. 9. UNDERGROUND UTILITIES— ALL NEW UTILITIES SHALL BE INSTALLED UNDERGROUND, EXCEPT WHERE SUCH PLACEMENT IS PROHIBITED OR DEEMED IMPRACTICAL BY THE UTILITY PROVIDER. UNDERGROUND FACILITIES FOR STREET LIGHTING ALONG ALL PUBLIC STREETS ABUTTING THE SUBJECT SITE SHALL BE

LANDSCAPE NOTES:

1. REFERENCE LANDSCAPE PLAN

1. ALL SITE LIGHTING SHALL BE LOCATED, ANGLED, SHIELDED AND/OR LIMITED IN INTENSITY SO AS TO CAST NO DIRECT LIGHT UPON ADJACENT PROPERTIES, SHALL MINIMIZE OFF-SITE BACKLIGHTING GLARE, AND UP-LIGHTING. LIGHT POST SHALL BE NO TALLER THAN TWELVE (12) FT.

<u>PARKING NOTES:</u>

- 1. NO PARKING REQUIRED FOR UMX
- 2. 15 SPACES SHOWN 3. BICYCLE PARKING
- 27 SPACES REQUIRED 4. PARKING MAXIMUM
- $(32 \times 2.5) + (2,878/200) = 94$ 5. Ì HANDICÁP SPACE REQUÍRED. 1 PROVIDED

1. VARIANCE REQUEST FOR 75 FT OFFSET FOR DRIVEWAYS ALONG MAJOR THOROUGHFARES

GENERAL NOTES:

- 1. NEW HANOVER COUNTY PARCEL NUMBERS.:
- PID = R05407 029 012 0002. TOTAL PROJECT AREA: 28,125 SF (0.65 AC.)
- 3. EXISTING ZONING DISTRICT: UMX 4. LAND CLASSIFICATION: URBAN
- 5. THIS SITE IS LOCATED WITHIN ZONE "X" ACCORDING TO FEMA FIRM COMMUNITY PANEL NUMBER 3720312700J, EFFECTIVE
- 6. SITE ADDRESS: 514 S. 17TH STREET
- 7. EXISTING IMPERVIOUS ONSITE = 11,180 SF
- 8. AS-BUILT, BOUNDARY AND TOPOGRAPHIC SURVEY PERFORMED AND PROVIDED TO CSD ENGINEERING BY CAPE FEAR SURVEYING;
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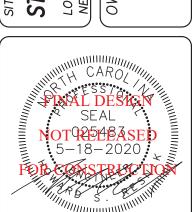


LICENSE # C-2710 **ENGINEERING** LAND PLANNING

COMMERCIAL / RESIDENTIAL P.O. BOX 4041

WILMINGTON, NC 28406 (910) 791–4441

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_	12	PLOTTED FOR TRC SIGNATURE, ADDED PHASE LINES	KL W	5-18-2
	11	REWSED TO SHOW PHASING	MRB	4-20-2
	10	ADDED PERVIOUS SIDEWAKK, REVISED IMPERVIOUS NUMBERS	RLW	3-9-20
	6	REVISED SIDEWALK, BUILDING AND NOTES	RLW	2-10-2
	8	REWSED UTILITIES	RLW	5-13-1
	7	REVISED SHEET NUMBERING PER NEW CFPUA DETAILS	MRB	1-18-1
	9	ADDED DIMENSION TO HC STALL PER NHC BUILDING REVIEW COMMENT	RLW	11-1-18
	5	CORRECTED DOMESTIC & FIRE WATER MAIN LINETYPES	MRB	10-9-1
	REV. NO.	REMARKS	ВУ	DAT


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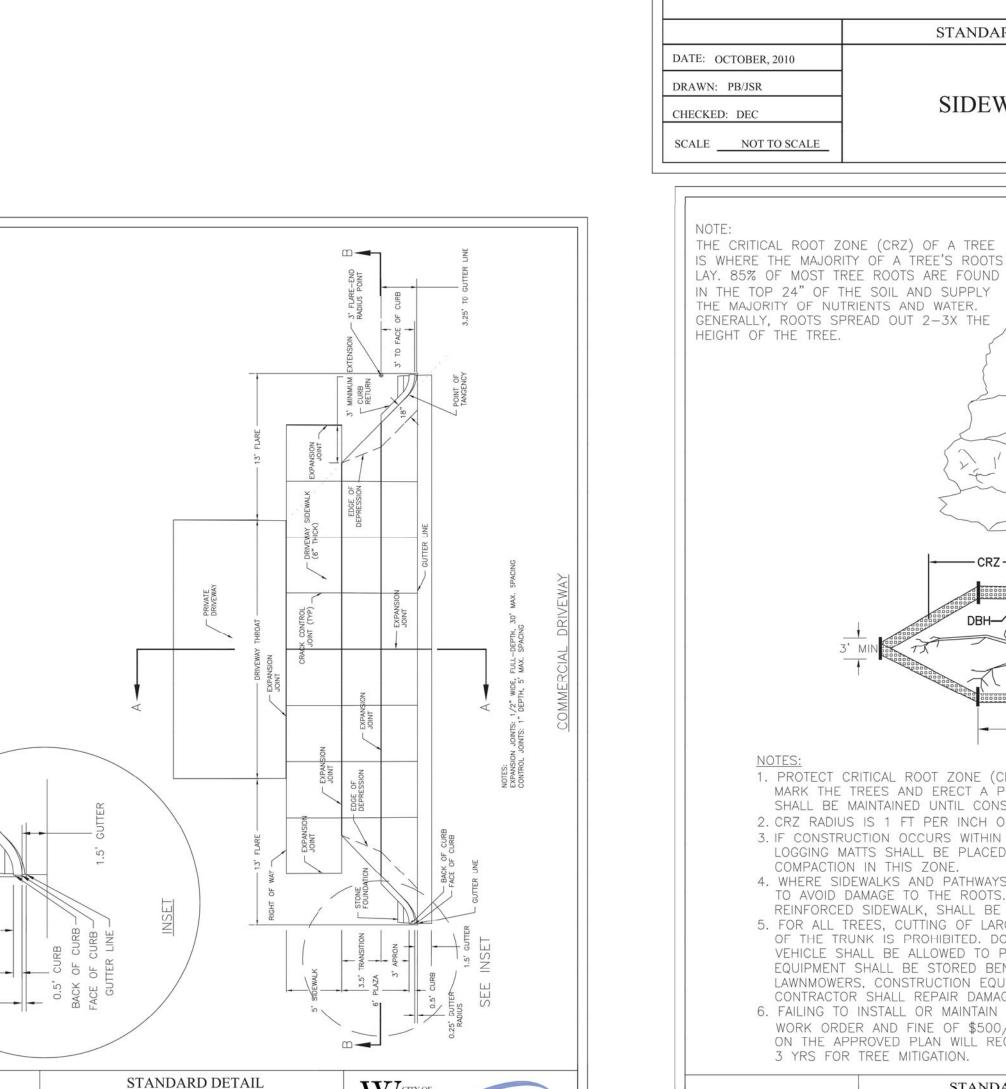
HORZ. SCALE: 1" = 20'VERT. SCALE: N/A

DRAWN BY: RLW CHECKED BY: HSR

PROJECT NO.: 17-0434

Sheet No. _____ Of _____



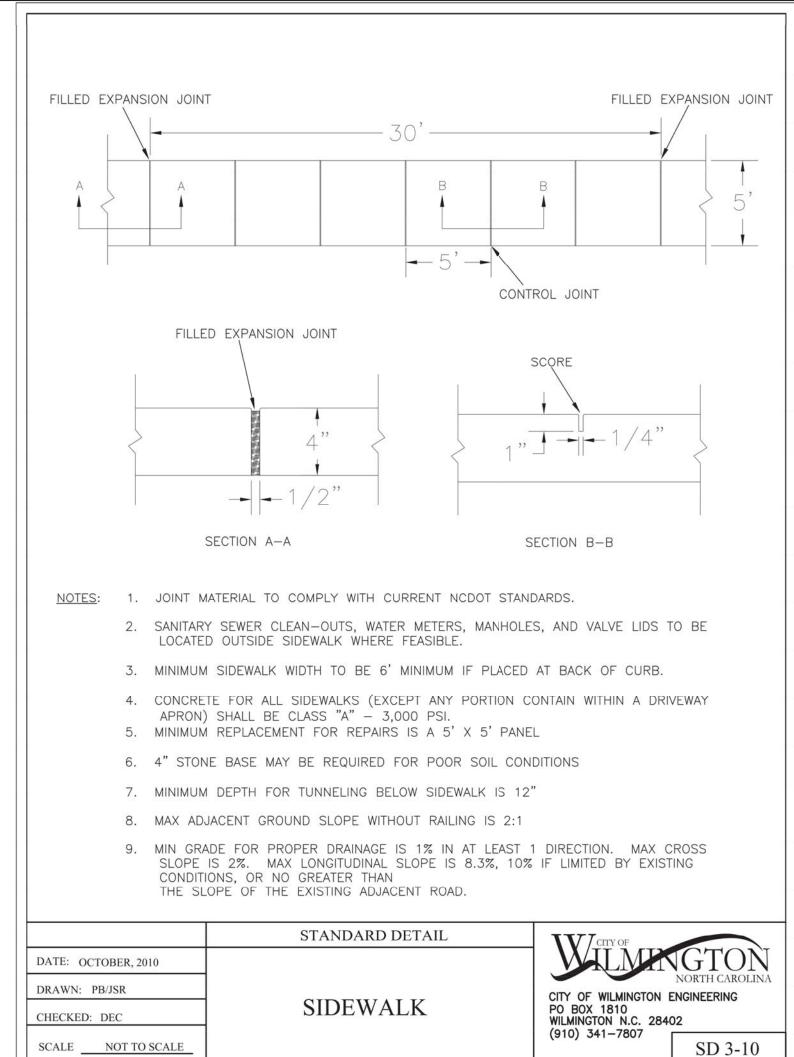

CITY OF WILMINGTON ENGINEERING

SD 3-03.3

PO BOX 1810 WILMINGTON N.C. 28402

(910) 341-7807

DATE: JUNE 1, 2015


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CHECKED BY D.E.C., P.E.

SCALE NOT TO SCALE

COMMERCIAL DRIVEWAY

PLAN

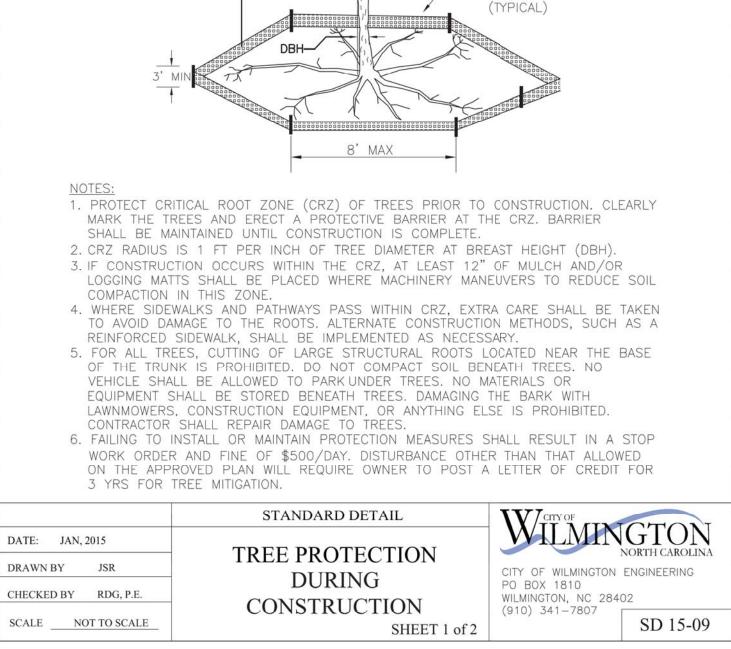

CROWN OF THE TREE IS NEEDED FOR LEAF


- ORANGE SAFETY FENCE


OR ORANGE SILT FENCE

GROWTH TO PRODUCE OXYGEN, FILTER THE AIR, REDUCE WIND AND SOFTEN NOISE.

DO NOT DISFIGURE CROWN WITH

INTENSIVE PRUNING.

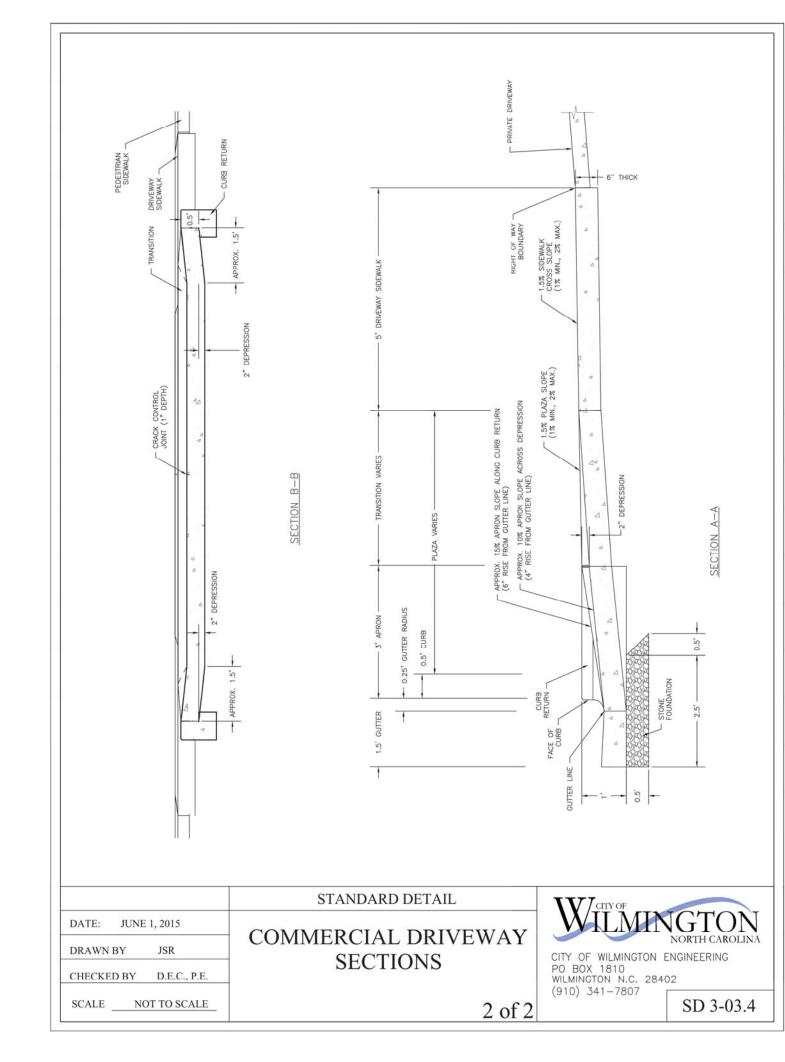

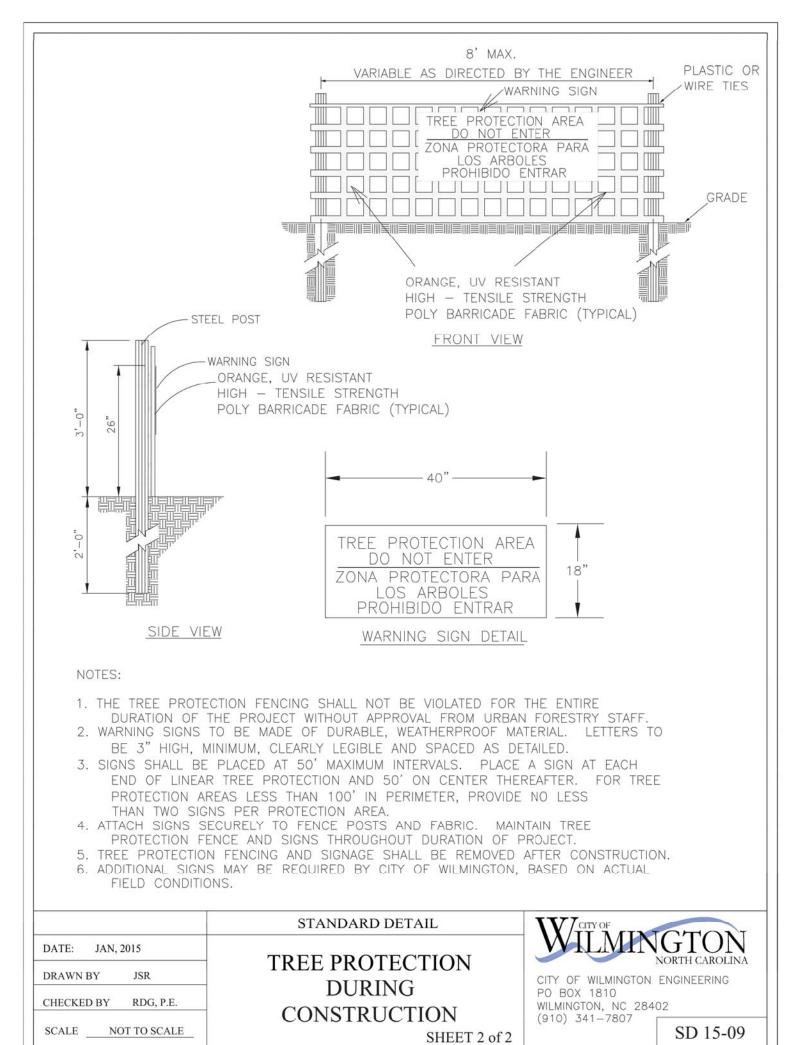





For each open utility cut of City streets, a \$325 permit shall be required from the City prior to occupancy and/or project acceptance.



LICENSE # C-2710
ENGINEERING
LAND PLANNING
COMMERCIAL / RESIDENTIAL


P.O. BOX 4041 WILMINGTON, NC 28406 (910) 791-4441


IUDIO 17 APARIMENIS

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ED IN CITY OF WILMINGTON
ANOVER COUNTY, NORTH CAROL
R: MOSLEY PARK, LLC
1319 MILITARY CUTOFF
SUITE CC PMB 172



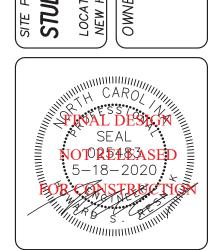

DATE: 1-22-18

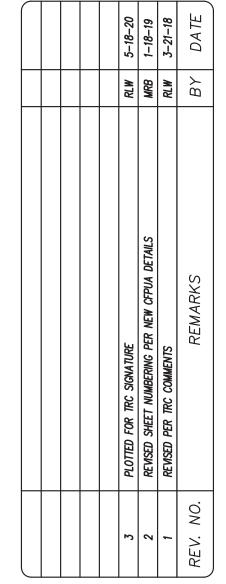
HORZ. SCALE: AS NOTED VERT. SCALE: N/A

DRAWN BY: RLW

CHECKED BY: HSR


PROJECT NO.: 17-0434


neet No. 4 Of 12

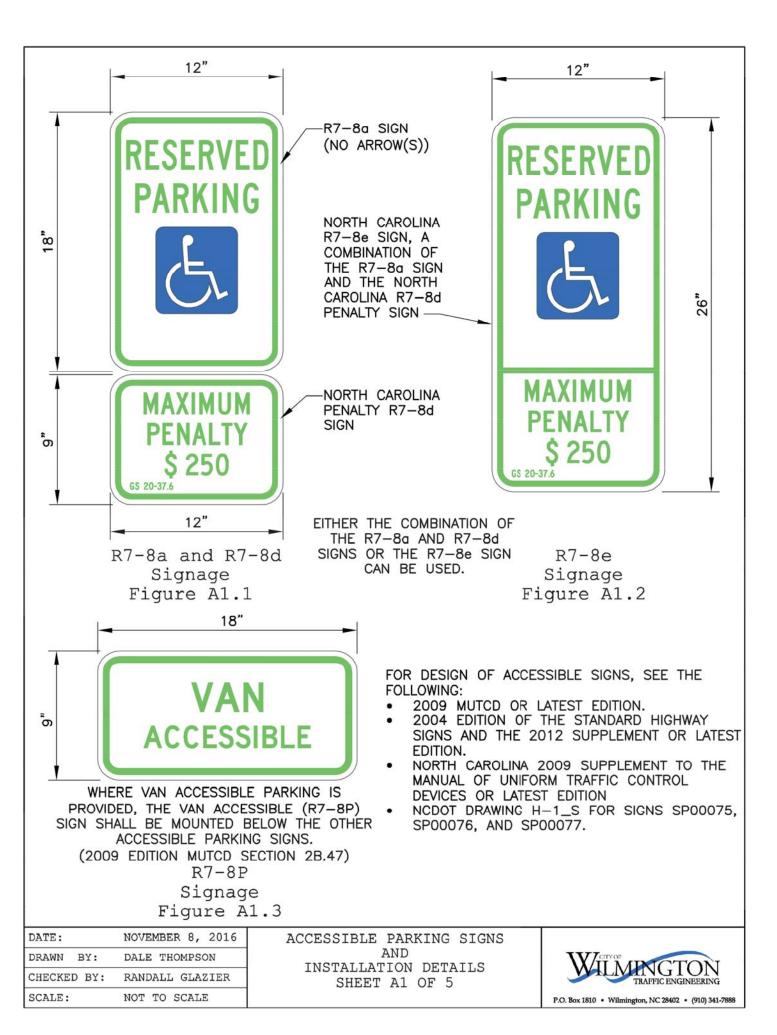

SCALE:

NOT TO SCALE

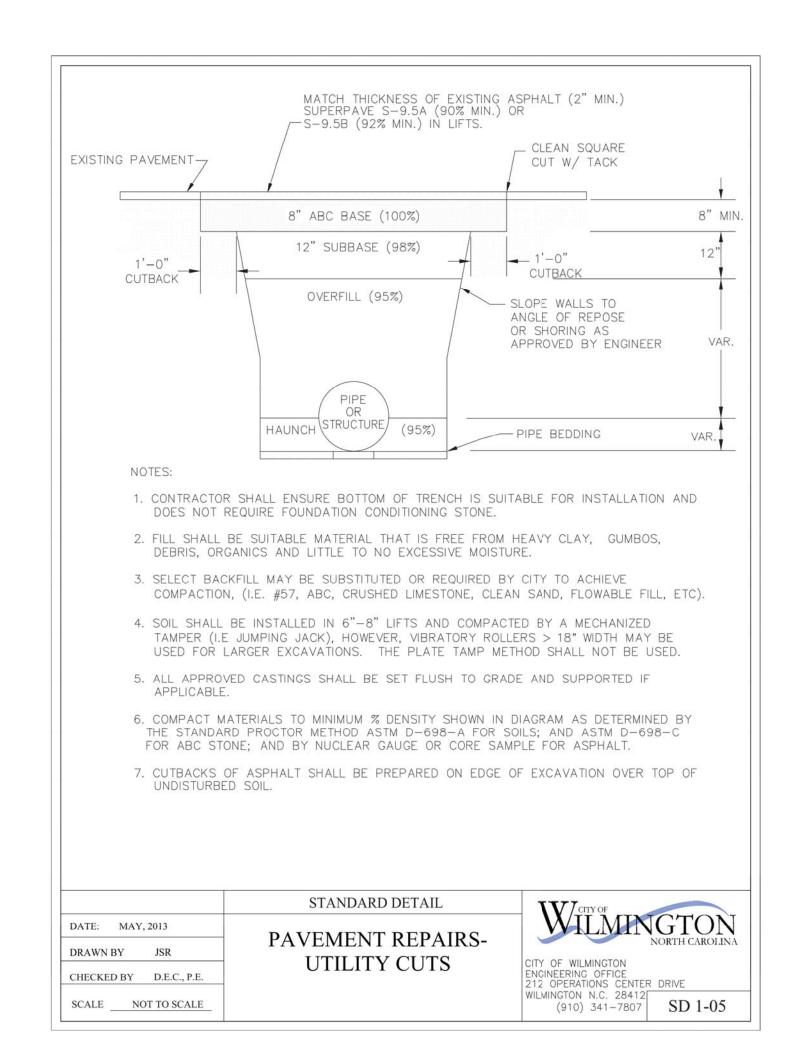


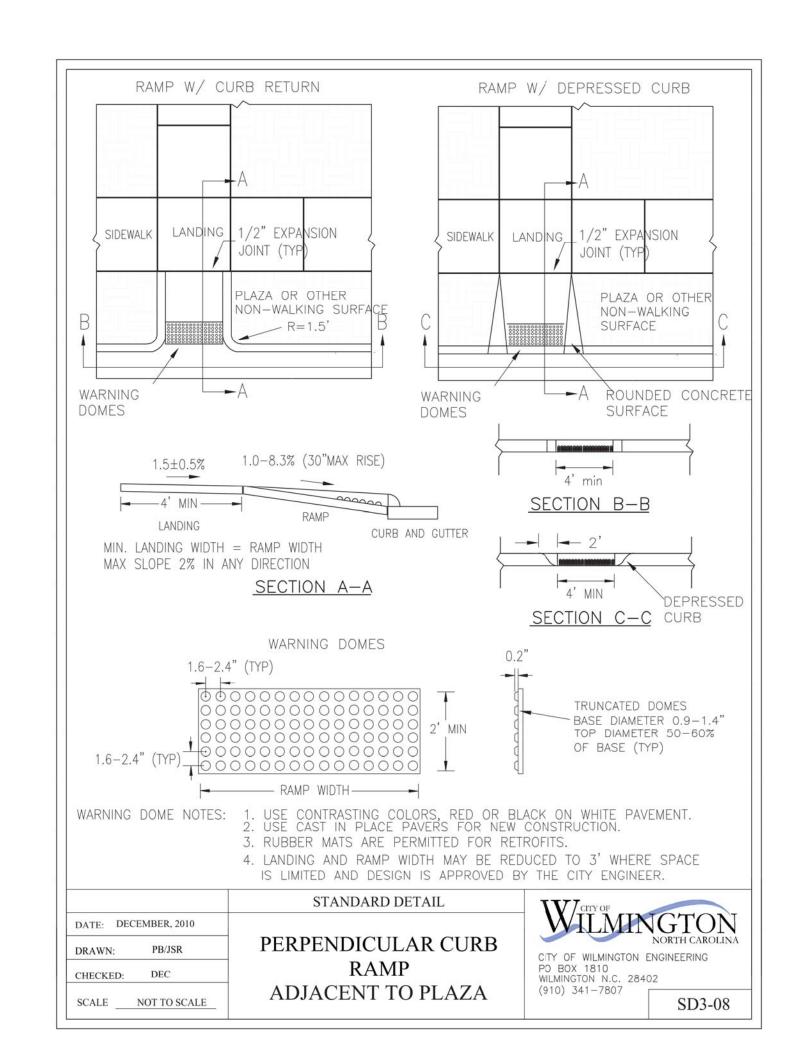



For each open utility cut of City streets, a \$325 permit shall be required from the City prior to occupancy and/or project acceptance.

ENGINEERING *LICENSE # C-2710* LAND PLANNING | COMMERCIAL / RESIDENTIAL Signed: _____ WILMINGTON, NC 28406

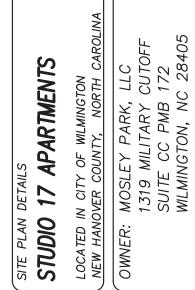


ENGINEERING

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PL 17







(DATE: 1-22-18

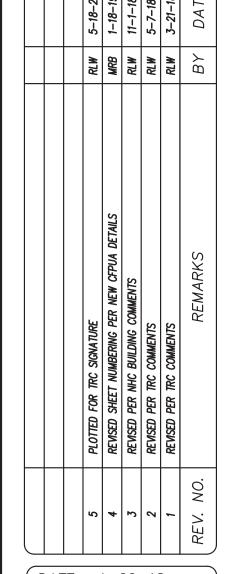
HORZ. SCALE: AS NOTED VERT. SCALE: N/A DRAWN BY: RLW CHECKED BY: HSR

PROJECT NO.: 17-0434

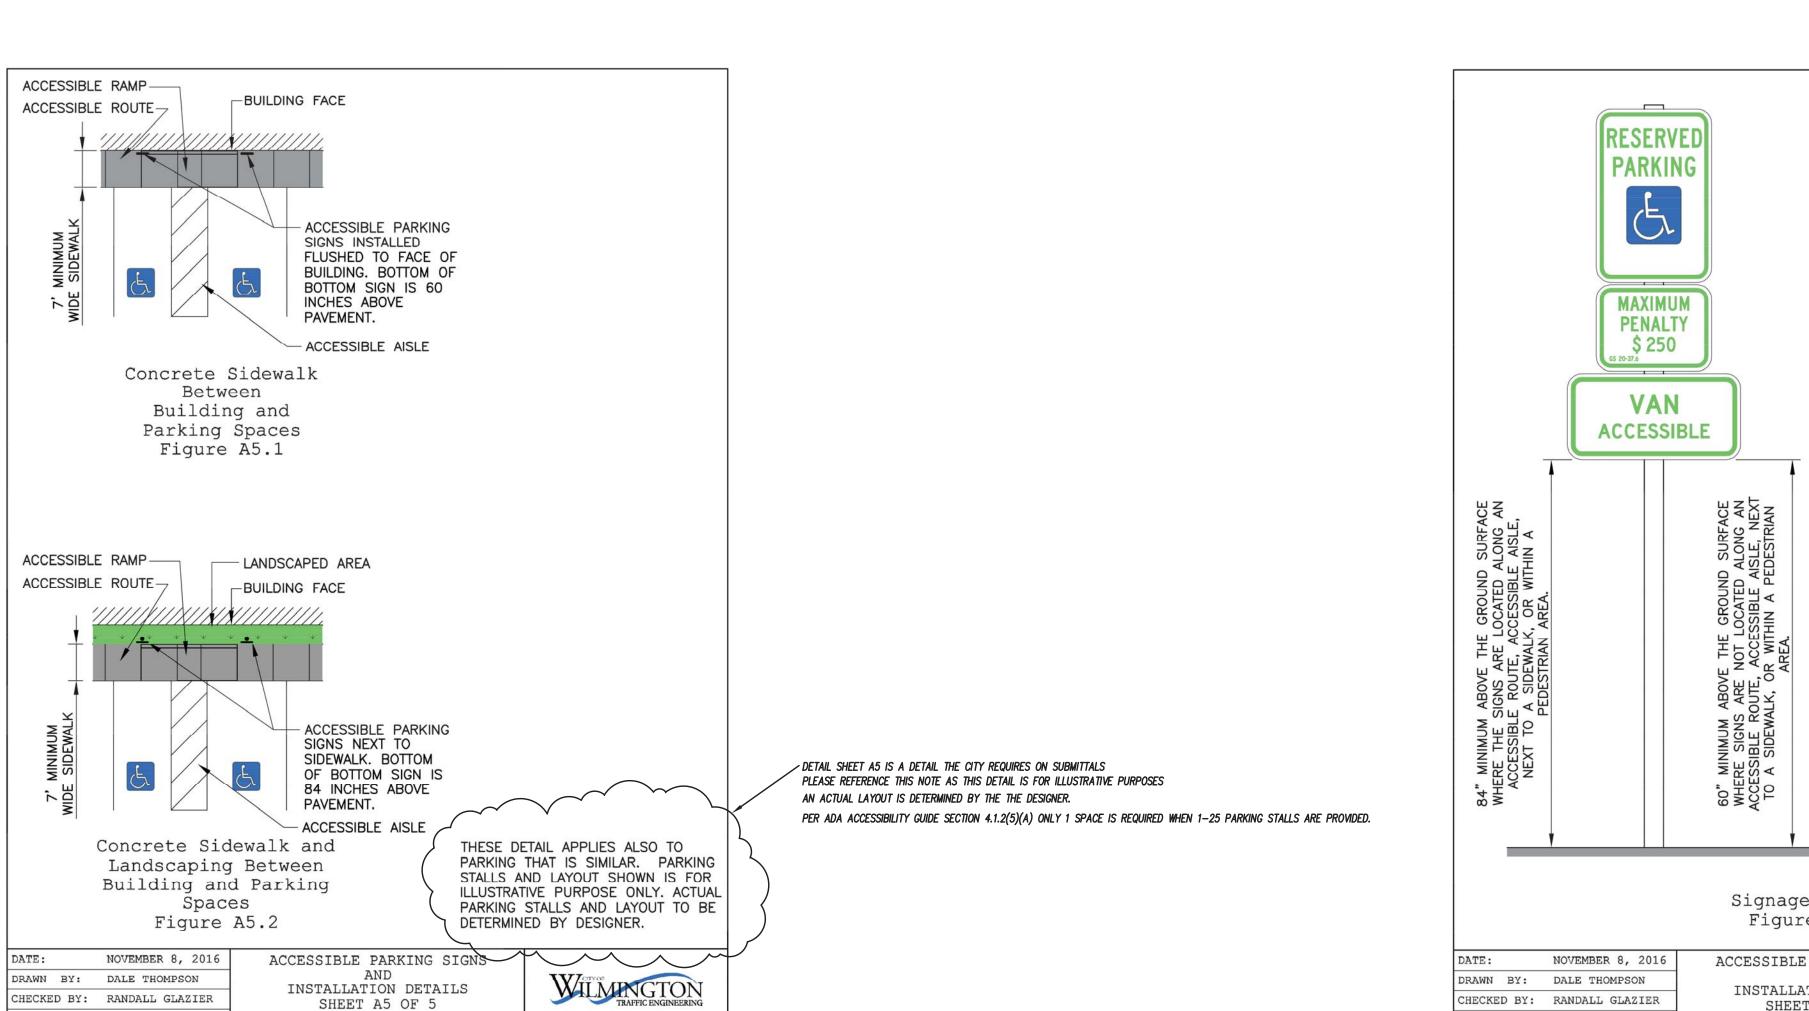

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1. CONTRACTOR SHALL NOT PROCEED WITH INSTALLATION OF SANITARY SEWER
COLLECTION SYSTEM UNTIL THE FOLLOWING HAS BEEN PERFORMED/PROVIDED.
2. PRIOR TO INSTALLATION OF CUT—IN MANHOLE, CONTRACTOR IS TO EXCAVATE
EXISTING SANITARY SEWER MAIN TO VERIFY EXISTING SEWER MAIN SIZE, LOCATION,
AND INVERT ELEVATION (HORIZONTAL AND VERTICAL DATA TO BE DETERMINED AND
PROVIDED BY NC REGISTERED PLS). THIS INFORMATION SHALL BE REPORTED BACK
TO THE DESIGN ENGINEER. SEWER INSTALLATION SHALL NOT PROCEED UNTIL
ENGINEER CONFIRMS EXISTING SEWER MAIN IS ADEQUATE TO SERVE SITE AND
SPECIFIC RIM AND INVERT DESIGN INFORMATION IS PROVIDED BY THE DESIGN
ENGINEER. ADDITIONAL COORDINATION WITH THE CFPUA MAY ALSO BE NECESSARY.
3. INFORMATION OBTAINED PER ITEM 1 ABOVE WILL ALSO BE UTILIZED TO DETERMINE
IF PROPOSED 6" SEWER MAIN WILL BE IN CONFLICT WITH THE EXISTING 15" STORM
DRAIN CROSSING THE SITE. IF A CONFLICT EXISTS, AN INTERFERENCE STRUCTURE
WILL BE REQUIRED AND THE DESIGN ENGINEER WILL PROVIDE PRECISE INVERT AND
SEPARATION INFORMATION FOR THE INSTALLATION.
4. ALL NEW 6" SEWER MAIN TO HAVE A MINIMUM OF 0.6% SLOPE.

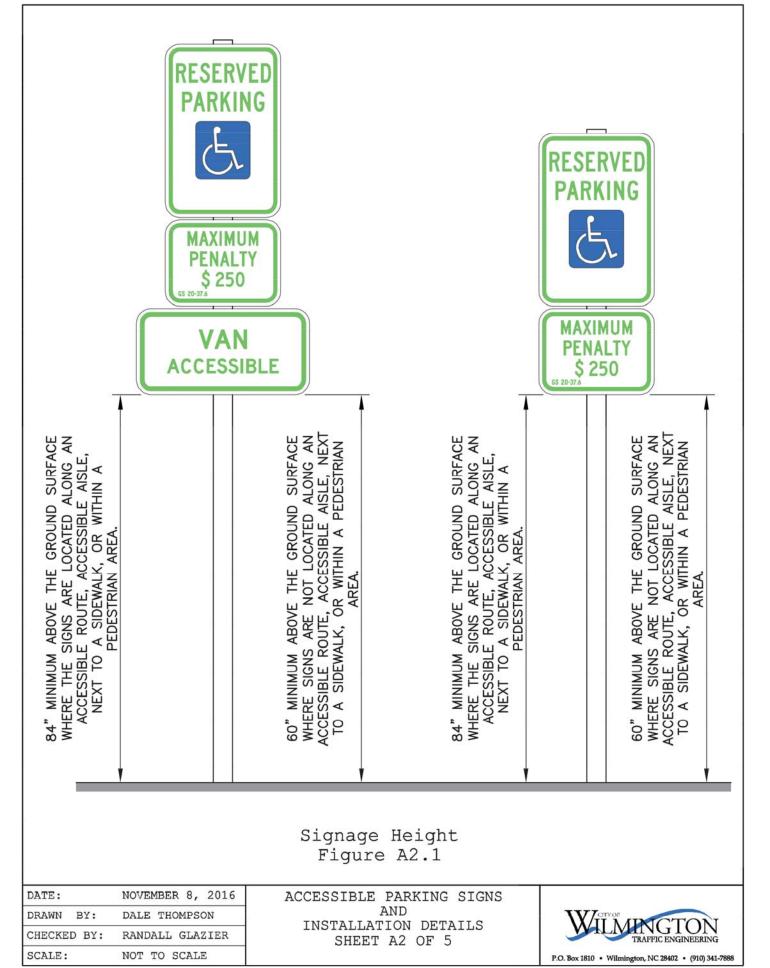EXISTING GROUND ELEVATION ALONG CENTERLINE ALIGNMENT

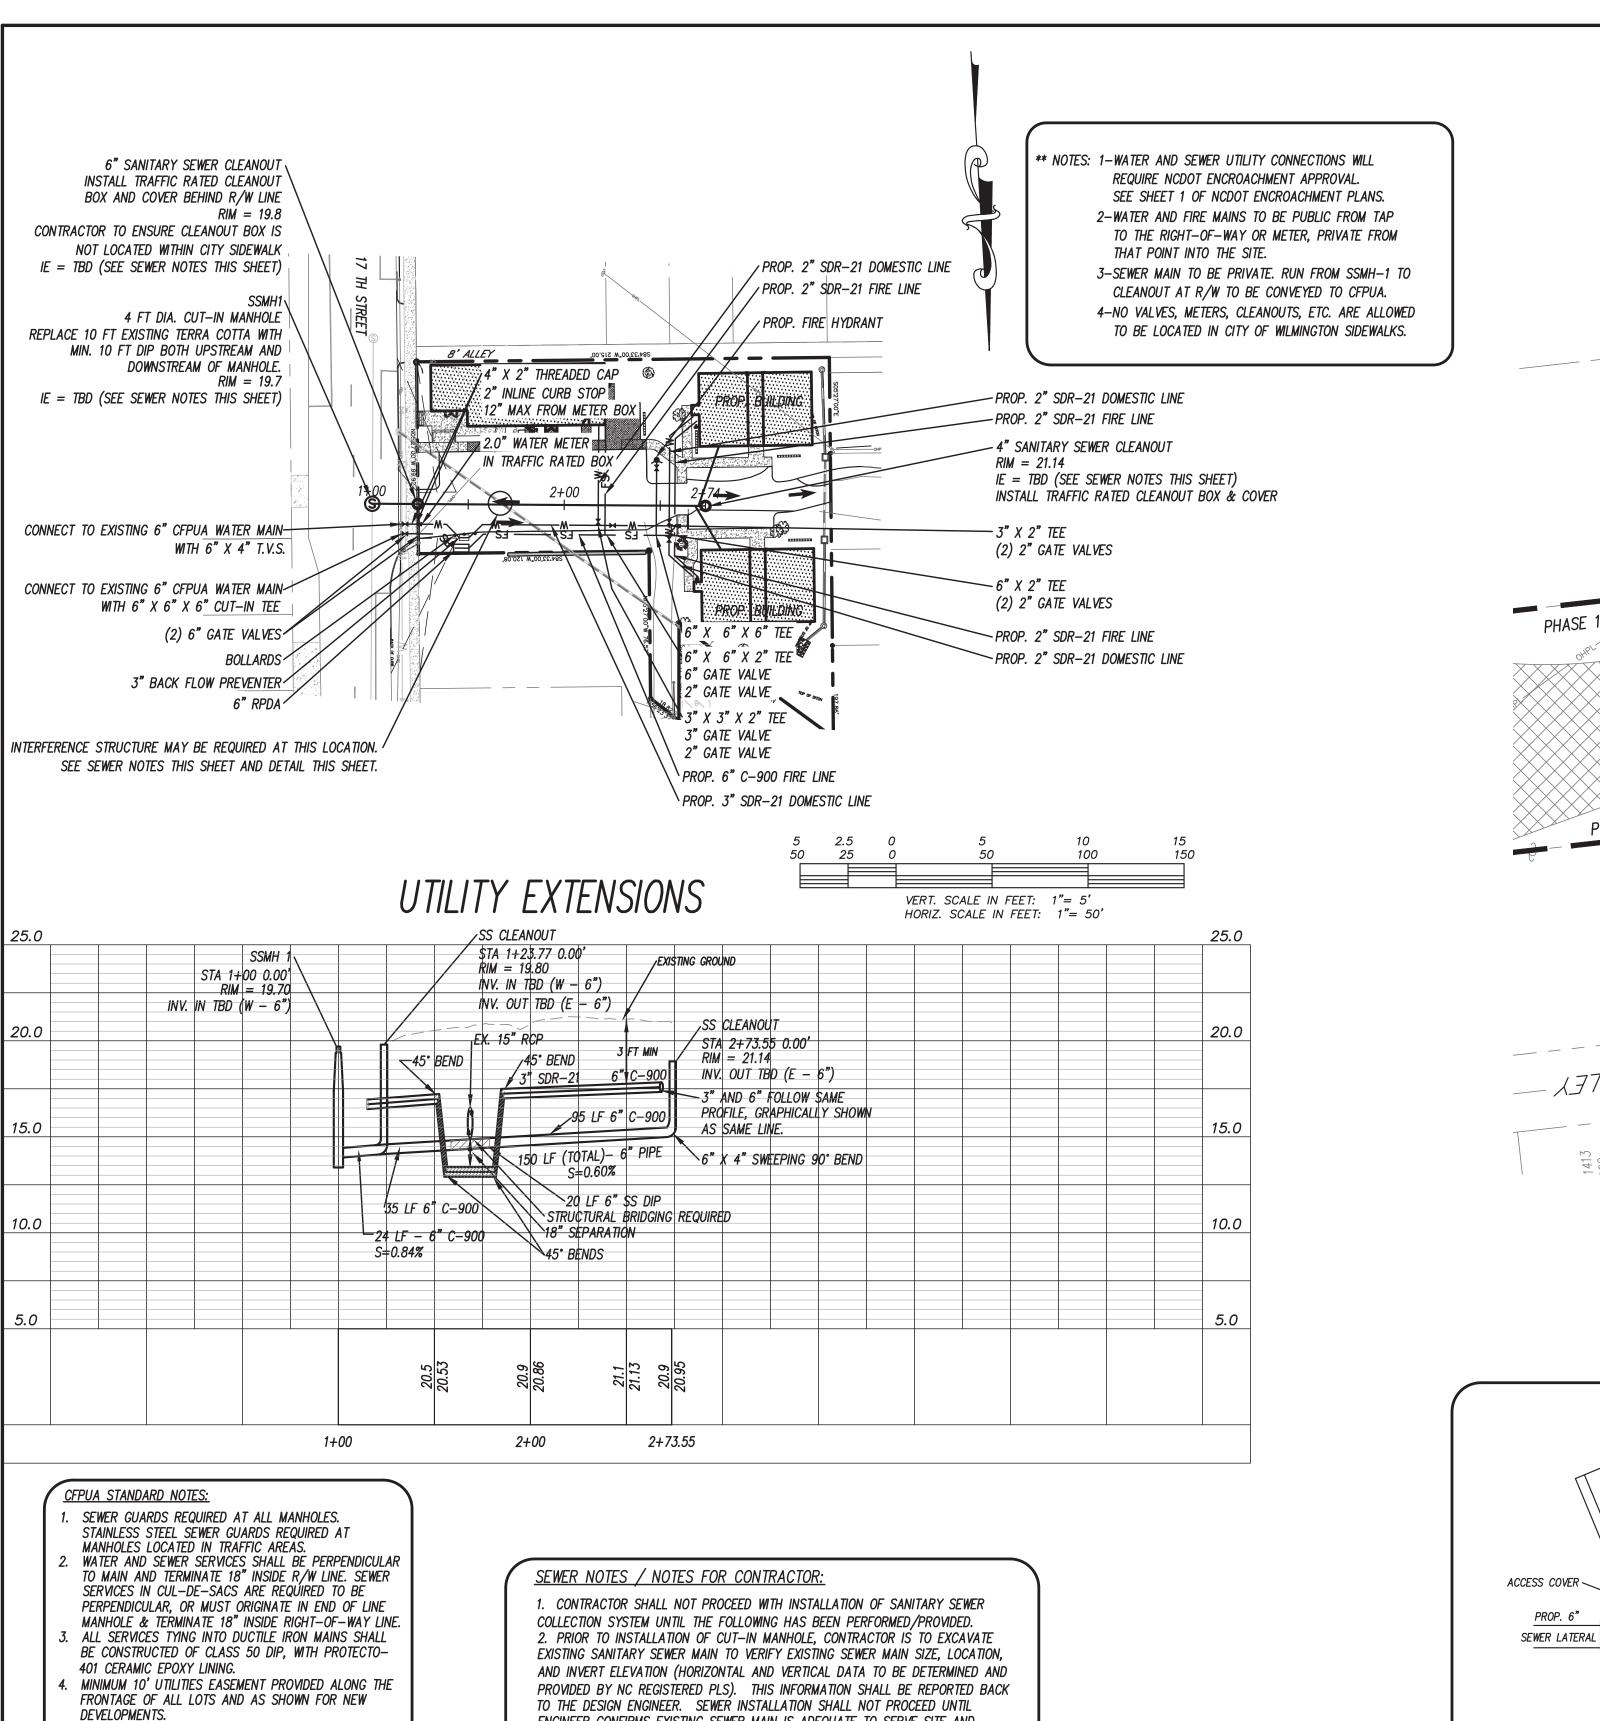PROPOSED FINISHED SURFACE CENTERLINE ELEVATION

1+00

PROPOSED CENTERLINE ALIGNMENT STATION

PROPOSED LEGEND

5. NO FLEXIBLE COUPLINGS SHALL BE USED.

FROM ALL PROPERTY CORNERS.

FROM THE PROPERTY CORNER.

SEWER MAINS.

6. ALL STAINLESS STEEL FITTINGS SHALL BE TYPE 316.

. CLEANOUTS SHALL BE LOCATED A MINIMUM OF 12 FEET

. WATER METER BOXES ARE TO BE A MINIMUM OF 5 FEET


. UNUSED SERVICES SHALL BE ABANDONED. ABANDONED


WATER SERVICES SHALL BE DISCONNECTED FROM MAIN.

10. A MINIMUM OF 10 FT OF MAIN LINE SHALL BE REPLACED FOR NEW CONNECTIONS TO EXISTING CLAY GRAVITY


For each open utility cut of City streets, a \$325 permit shall be required from the City prior to occupancy and/or project acceptance.

1177 over 00	
VILMINGTON	Approved Constructi
NORTH CAROLINA Public Services Engineering Division	Name Date
APPROVED DRAINAGE PLAN	Planning
Permit #	Traffic
d:	Fire_

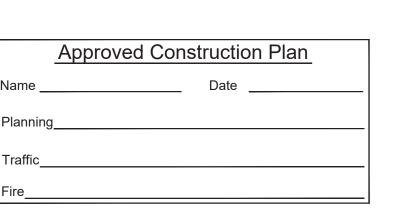

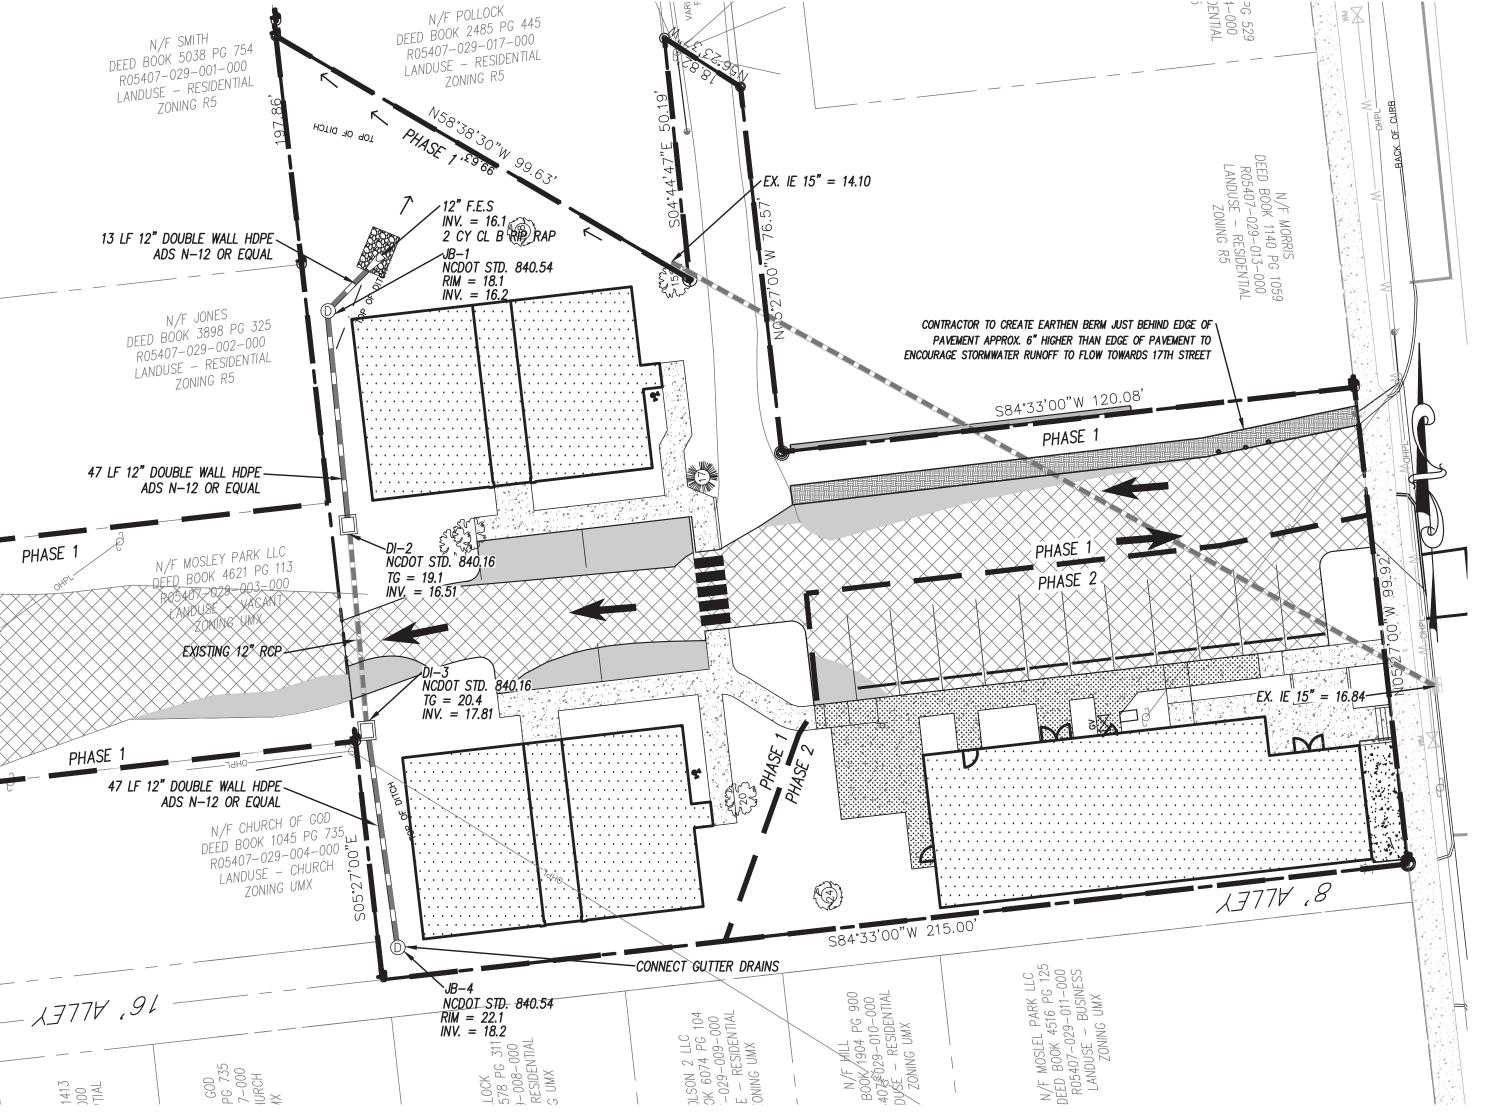


STORM DRAINAGE IMPROVEMENTS

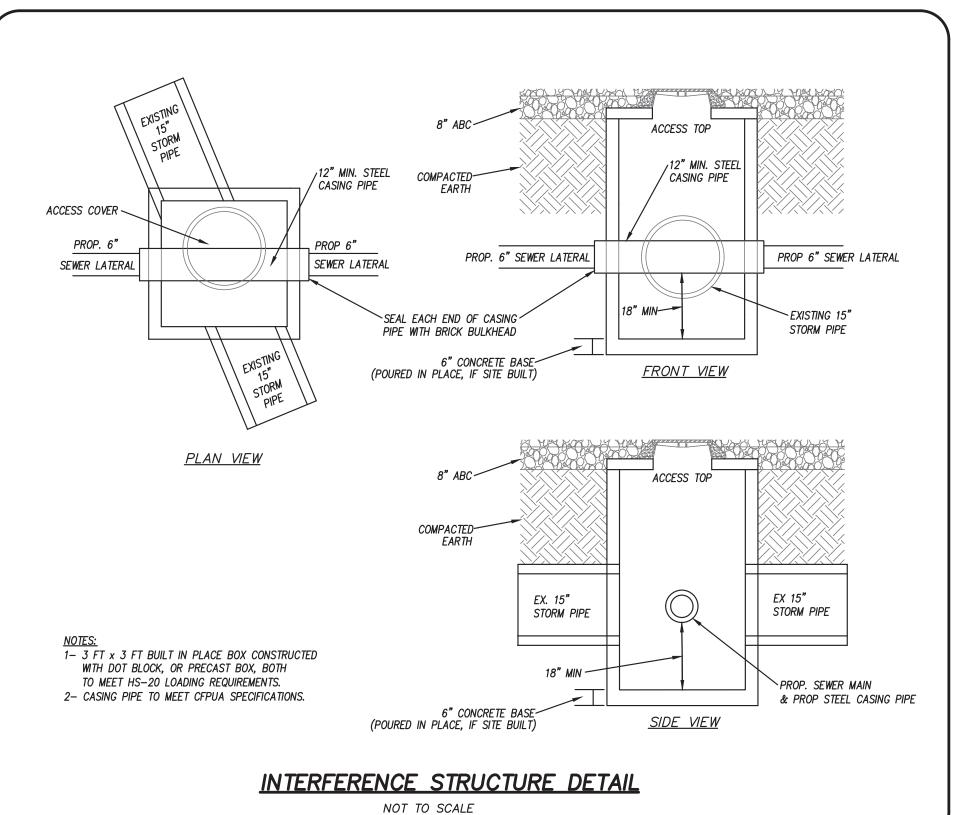

STORMWATER DRAINAGE STRUCTURE NOTES

- 1. CONTRACTOR AND PRECASTER TO DETERMINE STORM
- STRUCTURE SIZES.
 2. FRAME AND GRATES TO BE NCDOT 840.16
- 3. RING AND COVERS TO BE NCDOT STD. 840.54
 3. STORM STRUCTURES TO BE NCDOT STD. 840.14
- 5. CONTRACTOR TO INSTALL ACCESS COVERS SO THEY ARE NOT LOCATED WITHIN THE CURB AND GUTTER

4. PRECAST STORM STRUCTURES TO MEET HS-20-44

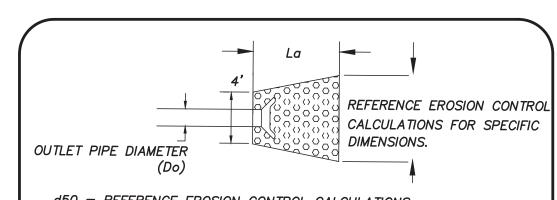

d50 = REFERENCE EROSION CONTROL CALCULATIONS dMAX = REFERENCE EROSION CONTROL CALCULATIONS La = REFERENCE EROSION CONTROL CALCULATIONS MIN. APRON THICKNESS = 4.5"

NOTE: GEOTEX NONWOVEN FILTER FABRIC (TERRATEX NO4 OR EQUAL)
TO BE PLACED UNDER ALL STONE
OUTLET PROTECTION.

	RIP RAP IMENSIONS		
STRUCTURE	LXWXD	CLASS	QUANTITY
OUTFALL FROM JB1	9' X 6' X 1'	В	2 CY

OP OUTLET PROTECTION DETAIL

NOT TO SCALE




LICENSE # C-2710
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STUDIO 17 APARTMENTS

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ED IN CITY OF WILMINGTON
HANOVER COUNTY, NORTH CAROLINA
ER: MOSLEY PARK, LLC
1319 MILITARY CUTOFF
SUITE CC PMB 172
WILMINGTON, NC 28405



 12	PLOTTED FOR TRC SIGNATURE	RLW	RLW 5-18-20
 11	REVISED TO SHOW PHASING	MRB	4-22-20
 10	REVISED BUILDING 3 AND SIDEWALK	RLW	2-10-20
 6	REVISED PER CFPUA COMMENTS	MRB	4-19-19
 8	REVISED WATER/FIRE MAIN LOCATION & WATER MAIN SIZE	MRB	2-26-19
 7	REWSED SHEET NUMBERING PER NEW CFPUA DETAILS	MRB	1-18-19
 9	CORRECTED DOMESTIC & FIRE WATER MAIN LINETYPES	MRB	10-9-18
 5	REVISED PER CFPUA COMMENTS	MRB	7-11-18
 REV. NO.	REMARKS	ВУ	BY DATE

DATE: 3-1-18

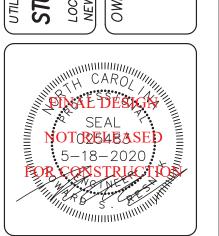
HORZ. SCALE: 1" = 10'
VERT. SCALE: N/A


DRAWN BY: RLW

CHECKED BY: HSR

PROJECT NO.: 17-0434

Sheet No. 6 of 12

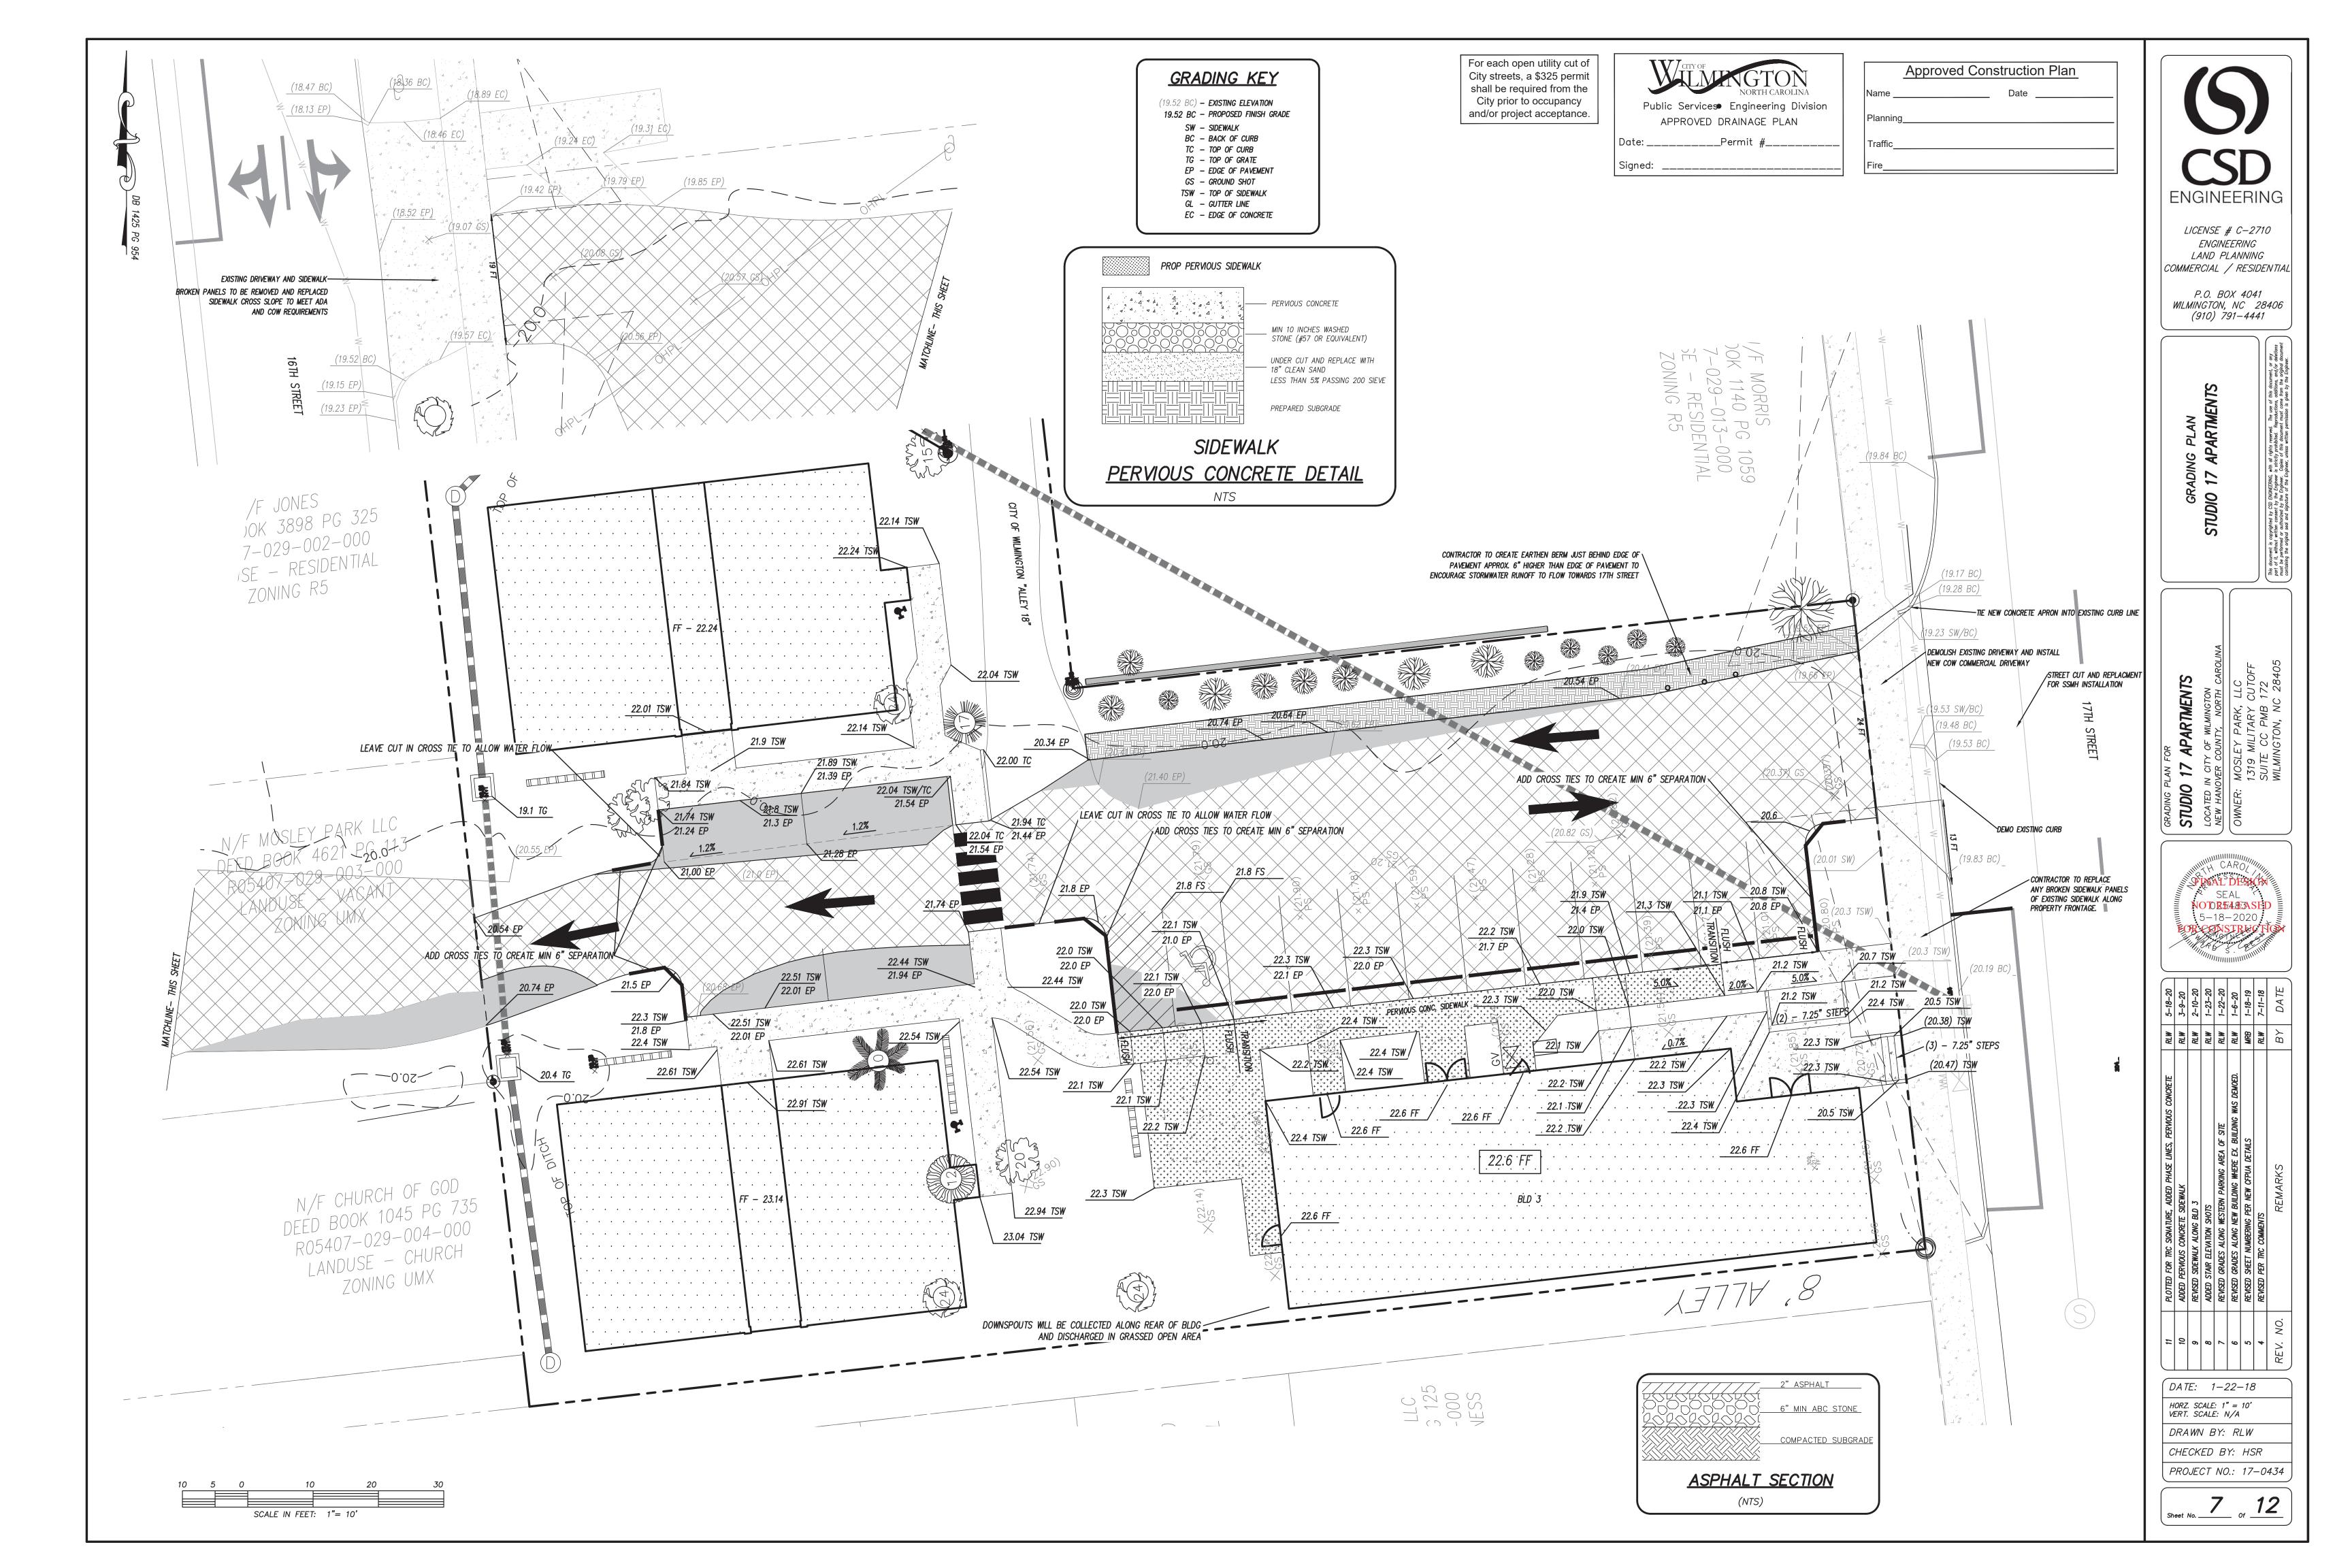

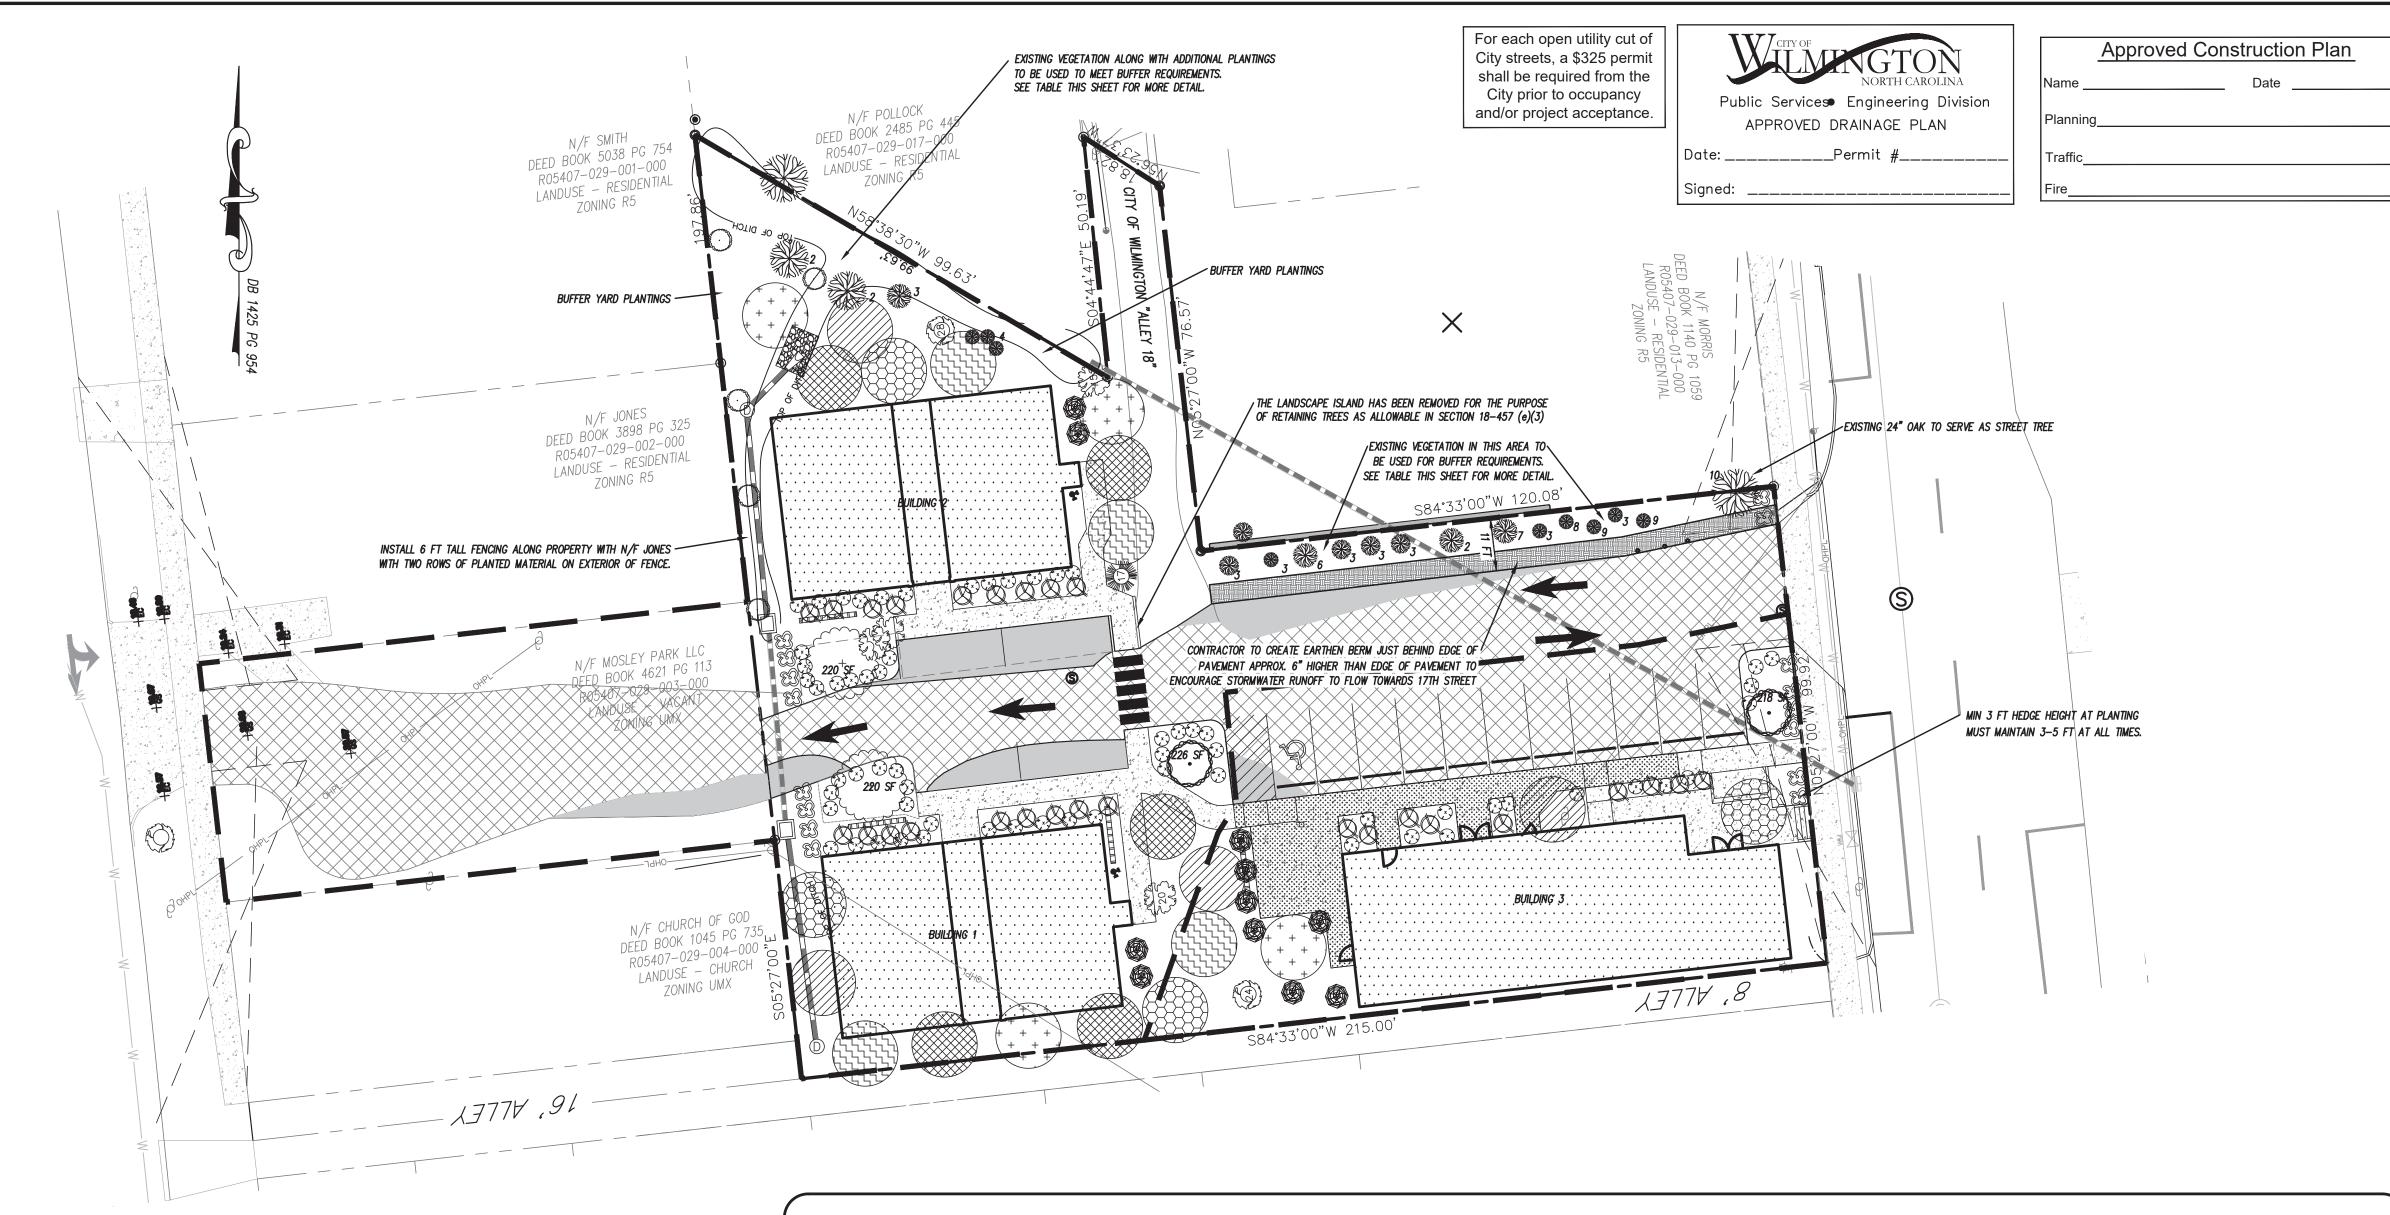

LANDSCAPING NOTES:

FOUNDATION PLANTINGS

NORTH SIDE BUILDING 1
BUILDING FACE = 1,800 SF

1,800 \times 0.12 = 216 SF REQ'D, 216 SF PROVIDED. SOUTH SIDE BUILDING 1 BUILDING FACE = 1,800 SF 1,800 \times 0.12 = 216 SF REQ'D, 216 SF PROVIDED.

NORTH SIDE BUILDING 3 BUILDING FACE = 2,715 SF

2,715 X 0.12 = 326 SF REQ'D, 336 SF PROVIDED.

<u>STREET TREES</u>

100 - 24 = 76 FT

76 / 30 = 2.5 STREET TREES REQUIRED

REQUESTING PAYMENT IN LIEU FOR STREET TREES DUE TO SITE

CONSTRAINTS. LESS THAN 3 FT FROM BACK OF CURB TO EXISTING

PARKING LOT SHADING

20% SHADING REQ'D FOR PARKING AREAS.

7,218 PARKING AREA X 20%; 7,218 X .2 = 1,444 SF REQ'D CANOPY

- 707 SF FOR CANOPY TREE

1,444 / 707 = 2.0 OR 2 CANOPY TREES; 2 CANOPY TREES PROVIDED.

<u>TREE MITIGATION</u>

SEE EXISTING CONDITIONS SHEET

33.6 - 13 = 20.6 MITIGATION TREES REQUIRED.
21 MITIGATION TREES SHOWN



TREES OR GROVES OF TREES.

NOTES:

1. ALL PROPOSED VEGETATION WITHIN SIGHT TRIANGLES SHALL NOT INTERFERE WITH CLEAR VISUAL SIGHT LINES FROM 30 INCHES — 10 FT.

2. STREET YARD SHRUBS SHALL BE AT LEAST 3 FEET IN HEIGHT

- AT TIME OF PLANTING.

 3. UNDERSTORY STREET YARD TREES MUST BE 8 10 FEET IN HEIGHT AT TIME OF PLANTING.
- AT TIME OF PLANTING.

 4. PRIOR TO ANY CLEARING, GRADING OR CONSTRUCTION ACTIVITY, TREE PROTECTION FENCING WILL BE INSTALLED AROUND PROTECTED
- 5. ALL LANDSCAPE ISLANDS TO INCLUDE GROUND COVER PLANTINGS.

SCALE IN FEET: 1"= 20'

	6 FT — 8 FT SHADOW BOX FENCE TO BE INSTALLED AROUND PERIMETER OF DUMPSTER PADS (12 FT X 12 FT). WAX MYRTLES (6 FT MIN.) ALONG FRONT OR CORNER SIDE OF ANY LOT AND 8 FT MIN. ALONG ANY SIDE OR REAR PROPERTY LINE ALONG SHADOW BOX FENCE.
	WAX MYRTLE——WAX MYRTLE——WAX MYRTLE——WAX MYRTLE (6 FT. MIN.) (6 FT. MIN.) (6 FT. MIN.) (REPEAT ALONG ENTIRE FENCELINE)
60	TRASH TOTE CORRAL (TYPICAL) N.T.S.

EXISTING BUFFER VEGETATION ID # DESCRIPTION 2 OLEANDER 3 LIGUSTRUM 4 POPLAR SHRUBS 6 PECAN TREE 7 14" OAK

CRAPE MYRTLE

24" LIVE OAK

PALM

10

NOTE: APPROXIMATE LOCATION AND DESCRIPTION
OF EXISTING VEGETATION PROVIDED TO CSD
ENGINEERING BY OWNERS.

Proposed Plant Table

Quantity	Symbol	Scientific Name	Common Name	Planting Size	Planting Remarks
PH1 10	~			MIN. 3 FT	PARKING AREA
PH2 6		llex crenata	STEEDS HOLLY	IN HEIGHT	SCREENING
PH1 25	0			7.04	PARKING AREA
PH2 4	☺	Muhlenbergia capillaris	PINK MUHLY	3 GAL.	GROUND COVER

INTERIOR PARKING TREE

Quantity	Symbol	Scientific Name	Common Name	Planting Size	Planting Remarks
PH1 1				7" DDU	INTERIOR TREE
PH2 1		Ulmus parvifolia	ALLEE ELM	3" DBH	INTERIOR TREE

FOUNDATION PLANTING

Quantity	Symbol	Scientific Name	Common Name	Planting Size	Planting Remarks
PH1 18	Ø	llex vomitoria	DWARF YAUPON	3 GAL.	FOUNDATION
PH2 9	X	liex voinitoria	DWANT TAOLON	0 0/12/	roonbrillon
PH1 23	€	Muhlophorgia ognillario	DIAIZ AJULI V	3 GAL.	FOUNDATION
PH2 11	\odot	Muhlenbergia capillaris	PINK MUHLY	J GAL.	TOUNDATION

SHADE TREES

Quantity	Symbol	Scientific Name	Common Name	Planting Size	Planting Remarks
PH1 2	ر. در کس	Quercus virginiana	SOUTHERN LIVE OAK	7" DDU	PARKING SHADING
PH2 -	\\\\\\\\\\\\\\\\\\\\\\\\\\\\\\\\\\\\\\	Quercus VII GIIII III II	SOUTHERN LIVE OAK	3" DBH	PARRING SHADING

DUMPSTER CORRAL & HVAC SCREENING

Quantity	Symbol	Scientific Name	Common Name	Planting Size	Planting Remarks
PH1 4		Myrica cerifera	WAX MYRTLE	7 Gal.	SCREENING
PH2 7			WAX MIRILE		

MITIGATION TREES

Quantity	Symbol	Scientific Name	Common Name	Planting Size	Planting Remarks	
PH1 5		Lagerstroemia indica	CRAPE MYRTLE	3" DBH	MITIGATION	
PH2 -		Lagersa oerma maica	CHAPL MINIEL	וומט כ		
PH1 2		Carpinus caroliniana	AMERICAN HORNBEAM	3" DBH	MITIGATION	
PH2 2		Curpinus curonnunu	AMENICAN HONNELAM	ווטט כ		
PH1 3	+ + + + + + + + + + + + + + + + + + + +	Ulmus americana 'Princeton'	PRINCETON ELM	3" DBH	MITIGATION	
PH2 1			T KINGLION LLW	ווטט כ		
PH1 3		Ulmus propinqua	EMERALD SUNSHINE ELM	3" DBH	MITIGATION	
PH2 1			EMERALD SUNSTITUTE ELM	ווטט כ		
PH1 2		Cinkan hiloha (male only)	GINKGO	3" DBH	MITIGATION	
PH2 2		Ginkgo biloba (male only)	OHNOU			

BUFFER YARD

	Quantity	Symbol	Scientific Name Common Name		Planting Size	Planting Remarks
	PH1 5	0	Nyssa sylvatica	BLACK GUM	3" DBH	BUFFER YARD
	PH2 -			BEAGN GOM	<i>5 DBH</i>	
	PH1 13		Myrica cerifera		7.01	BUFFER YARD
	PH2 -			WAX MYRTLE	7 Gal.	

O.C. — "ON CENTER" CAL. — "CALIPER AT 6" ABOVE GRADE" GAL. — "GALLON CONTAINER" STREET YARD SHRUBS SHALL BE AT LEAST 12" HEIGHT AT PLANTING.




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LANDSCAPE PLAN
STUDIO 17 APARTMENTS

HANOVER COUNTY, NORTH CAROLINA
HANOVER COUNTY, NORTH CAROLINA
IER: MOSLEY PARK, LLC
1319 MILITARY CUTOFF
SUITE CC PMB 172



5-18-20	4-22-20	2-10-20	8-2-18	7-23-18	7-11-18	6-19-18	5-29-18	BY DATE
RLW	MRB	RLW	MRB	MRB	RLW	MRB	RLW	ВУ
PLOTTED FOR TRC SIGNATURE	REVISED TO SHOW PHASING	REVISED PER SIDEWALK AND BUILDING CHANGES AROUND BLD 3	REVISED PER CITY ARBORIST COMMENTS	REVISED PER TRC COMMENTS	REWSED TREE MITIGATION CALCS & ADDED TABLE	REVISED EXISTING TREES & PROPOSED PLANTINGS	REVISED PER TRC COMMENTS	REMARKS
6	8	2	9	5	4	3	2	REV. NO.

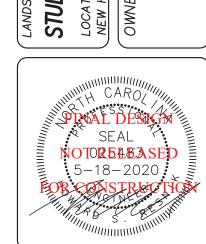DATE: 3-1-18

HORZ. SCALE: 1" = 20'
VERT. SCALE: N/A

DRAWN BY: RLW

CHECKED BY: HSR
PROJECT NO.: 17-0434

Sheet No. LP of LP